

В

PIPING LEGEND					
cw	DOMESITC COLD WATER				
CW	DOMESTIC COLD WATER BELOW GRADE				
TP	TRAP PRIMER				
———— — — нw	DOMESTIC HOT WATER				
	WASTE				
	WASTE BELOW GRADE				
	VENT				
NG	NATURAL GAS, 14 IN WG, 0.60 SG				
	STORM DRAIN				
SD	STORM DRAIN BELOW GRADE				
FW	FIRE WATER MAIN				

PIPING IN	SULATION S	SCHEDULE						
			MINIMUM INSULATION THICKNESS (IN) FOR NOMINAL PIPE DIAMETERS LISTED (IN)					
SERVICE	LOCATION	INSULATION CONDUCTIVITY (Btu/in)/(hr-ft-F)	RUNOUTS UP TO 2	1 AND LESS	1-1/4 TO 2	2-1/2 TO 4	5 AND 6	
DOMESTIC COLD WATER (CW)	INDOORS	0.24 - 0.28	0.5	0.5	1.0	1.0	1.0	
DOMESTIC HOT WATER (HW)	INDOORS	0.24 - 0.28	0.5	1.0	1.0	1.5	1.5	

NOTES:

1. RUNOUTS REFERENCED ABOVE NOT TO EXCEED 12 FEET IN LENGTH.

2. PIPE INSULATION TO INCLUDE ALL—PURPOSE FACTORY BONDED VAPOR BARRIER JACKET. PROVIDE INSULATION AND INSULATION COVERS (ZESTON 2000 OR EQUAL) FOR FITTINGS.



GENERAL NOTES

- 1. THESE DRAWINGS ARE DIAGRAMMATIC; THEY DO NOT SHOW EVERY OFFSET, BEND, TEE, OR ELBOW WHICH MAY BE REQUIRED TO INSTALL WORK IN THE SPACE PROVIDED AND AVOID CONFLICTS. THE CONTRACTOR SHALL FOLLOW THE DRAWINGS AS CLOSELY AS IS PRACTICAL TO DO SO AND INSTALL ADDITIONAL BENDS, OFFSETS, TEES, AND ELBOWS WHERE REQUIRED BY LOCAL CONDITIONS FROM MEASUREMENTS TAKEN AT THE SITE, SUBJECT TO APPROVAL, AND WITHOUT ADDITIONAL COST TO THE OWNER.
- 2. PLUMBING SYSTEMS AND MATERIALS SHALL BE IN ACCORDANCE WITH THE FOLLOWING CODES:
 - 2006 IBC WITH OREGON AMENDMENTS 2006 IMC WITH OREGON AMENDMENTS 2003 UPC WITH OREGON AMENDMENTS
- 3. PROVIDE SEISMIC RESTRAINTS IN ACCORDANCE WITH MASON INDUSTRIES "SEISMIC RESTRAINT GUIDELINES" (OR SIMILARLY RECOGNIZED GUIDE) FOR PIPING AS FOLLOWS:
 - DUCTILE PIPING 2-1/2" AND LARGER.
 ALL NON-DUCTILE PIPING (THREADED IRON, PLASTIC, ETC.).
 - DUCTILE PIPING 1" AND LARGER CONVEYING FUEL GAS.
 PIPE RACKS WHERE THE CUMULATIVE WEIGHT OF THE PIPING EXCEEDS 10 LBS PER LINEAL FOOT.
- 4. SEISMICALLY RESTRAIN EQUIPMENT IN ACCORDANCE WITH LOCAL CODE REQUIREMENTS FOR SEISMIC IMPORTANCE FACTOR 1.0.
- 5. INSTALL EQUIPMENT IN ACCORDANCE WITH MANUFACTURER'S INSTRUCTIONS.
- 6. SANITARY WASTE SLOPE*:
 PIPE SIZES 3" AND LARGER SLOPE LINES AT 1/8" PER FOOT
 PIPE SIZES 2-1/2" AND SMALLER SLOPE LINES AT 1/4" PER FOOT
 * UNLESS OTHERWISE NOTED.
- 7. SLOPE STORM DRAIN LINES AT 1/8" PER FOOT UNLESS OTHERWISE NOTED.
- 8. THE PLUMBING CONTRACTOR SHALL EXECUTE ALL WORK SO THAT IT PROCEEDS WITH A MINIMUM OF INTERFERENCE WITH OTHER TRADES AND NORMAL FUNCTIONS OF EXISTING FACILITIES AND SERVICES.
- 9. VERIFY EXACT ROUGH-IN AND FINAL EQUIPMENT REQUIREMENTS IN FIELD.
- 10. PROVIDE FIRE SEALANT AT PENETRATIONS OF FIRE RATED ASSEMBLIES; COORDINATE REQUIREMENTS (E.G., F&T RATING, ASSEMBLY DETAILS) WITH ARCHITECT AND GENERAL CONTRACTOR.
- 11. THE PLUMBING CONTRACTOR SHALL COORDINATE WITH THE GENERAL CONTRACTOR AND OTHER TRADES, ALL REQUIRED OPENINGS AND EXCAVATIONS. ALL REQUIRED OPENINGS IN FOUNDATIONS, FLOORS, WALLS, AND ROOFS SHALL BE DESIGNED INTO THE STRUCTURE INITIALLY BY THE USE OF SLEEVES, CURBS, ETC. CUTTING AND PATCHING SHALL BE HELD TO A MINIMUM.
- 12. PROVIDE DI-ELECTRIC UNIONS AT ALL DISSIMILAR METAL PIPE CONNECTIONS.
- 13. PROVIDE PIPE MARKERS IN ACCORDANCE WITH ASME 13.1 SCHEME FOR THE IDENTIFICATION OF PIPING SYSTEMS; BRADY, SETON, OR EQUAL.
- 14. NOT ALL CLEANOUTS ARE SHOWN; CONTRACTOR IS RESPONSIBLE FOR PROVIDING CLEANOUTS IN ACCORDANCE WITH THE OSPC; COORDINATE LOCATIONS OF CLEANOUTS WITH GC/OWNER REPRESENTATIVE.
- 15. PROVIDE FDA APPROVED PVC JACKETING FOR INSULATED PIPING SYSTEMS IN WASHDOWN AREAS; COORDINATE REQUIREMENTS WITH OWNER REPRESENTATIVE.
- 16. PROVIDE "SANITARY" PIPE SUPPORT CONFIGURATIONS IN ACCORDANCE WITH HEALTH CODE REQUIREMENTS FOR FOOD HANDLING AND WASHDOWN AREAS; COORDINATE REQUIREMENTS WITH OWNER REPRESENTATIVE.

LRS a

.

720 NW Davis
Suite 300
Portland, OR 97209
Tel. 503 221 1121

Portland, OR 97209
Tel. 503.221.1121
Fax. 503.221.2077

Munro & Associates consulting engineers

18678 SW Boones Ferry Rd Tualatin, Oregon 97062 tel 503.612.6500 fax 503.612.6588

CONSULTANTS

A TION AND ADDITION
SATION AND ADDITION
SATE SW O'MARA ST.
SARD, OREGON 97223
AND COVER SHEE

PROJECT NAME

09.20.07

CHECK: LD

DRAWN BY: RMT

PROJECT: 207037

PI 0

Copyright © 2005 LRS Architects, Inc.

TAG		KITCHEN CONSULTANT		CONI	NECTION	SIZE			
NO.	QTY	DESCRIPTION	GAS	CW	HW	THW	W	COMMENTS	NOTES
4	1	MOP SINK		1/2	1/2		3	MUSTEE 63M, MUSTEE 63.600 FAUCET	
13	1	STAINLESS STEEL SINK, 8" DEEP W/ SPRAYER		1/2	1/2		1.5	ELKAY LR2521, FAUCET W/ SPRAYER	2" DRAIN
16	1	48" STOVE, GAS COOK TOP, ELECTRIC CONVECTION OVEN BELOW.	3/4			decide vibritie		US RANGE, GARLAND	128 MBH INPU
23	1	MULTI-COMPARTMENT STAINLESS STEEL SINK WITH SPRAYER		1/2 QTY.2	1/2 QTY.2	****	FS	ELKAY	2 FAUCETS
24	1	COMMERCIAL DISHWASHER AND BOOSTER HEATER	****		3/4		FS	JACKSON TEMPSTAR	BUILT-IN PRV
28	1	STAINLESS STEEL HAND WASH SINK		1/2	1/2	6940 MAGA	1.5	ELKAY LRAD 1219	ADA, 2" DRAIN
30	1	DROP-IN REFRIGERATED WELLS	Access species			****	FS	DUKE ADI-3M	

- 1. KITCHEN FIXTURES FURNISHED BY FOOD SERVICE EQUIPMENT CONTRACTOR; SEE ARCHITECTURAL KITCHEN DRAWINGS FOR EXACT DIMENSIONS AND CONNECTIONS TO EQUIPMENT; COORDINATE WITH FOOD SERVICE CONTRACTOR AND GENERAL CONTRACTOR.
- 2. INSTALL FAUCETS, DRAINS, AND OTHER FOOD SERVICE EQUIPMENT CONTRACTOR-FURNISHED ITEMS; PROVIDE SPEEDWAY STOPS AND SUPPLIES.

PROVIDE MODEL NUMBERS INDICATED, OR EQUIVALENT.

PLUMBIN	G FIXTURE SCHEDULE 2		
FIXTURE	TYPE	DESIGN BASIS	DESCRIPTION
FD1	FLOOR DRAIN	J.R. SMITH DX2005A	FLOOR DRAIN WITH DUCO CAST IRON BODY WITH 4" WIDE FLANGE AND SECONDARY FLASHING FLANGE, COLLAR, AND ADJUSTABLE ROUND BRONZE STRAINER HEAD, SEDIMENT BUCKET, NO-HUB OUTLET, NICKEL-BRONZE STRAINER, VANDAL-PROOF SCREWS.
FD2	FLOOR DRAIN	J.R. SMITH 2220	FLOOR DRAIN WITH DUCO CAST IRON BODY WITH FLASHING, COLLAR, ROUND BRONZE STRAINER HEAD, SEDIMENT BUCKET, NICKEL BRONZE TOP, TRAP PRIMER CONNECTION, NO—HUB OUTLET AND VANDAL PROOF GRATE. TAP AND THREAD BUCKET AND GRATE TO ATTACH TO DRAIN BODY.
FS1	FLOOR SINK	J.R. SMITH DX3001	SANI-CEPTOR, 12" SQUARE TOP WITH WIDE FLANGE, SS TOP RECEPTOR, SS 1/2 GRATE, BOTTOM DOME STRAINER.
RD1	ROOF DRAIN	J.R. SMITH 1010Y	ROOF DRAIN WITH DUCO CAST IRON BODY, FLASHING CLAMP, EXPANSION JOINT, NO-HUB OUTLET, SUMP RECEIVER, UNDERDECK CLAMP
WHA-1	WATER HAMMER ARRESTER	PRECISION PLUMBING PRODUCTS SC-500	1" (PDI SIZE C) WATER HAMMER ARRESTER.
FCO	FLOOR CLEANOUT	J.R. SMITH 4020	ADJUSTABLE FLOOR CLEANOUT, DURA COATED CAST IRON BODY, WITH ROUND SCORIATED SECURED NICKEL BRONZE TOP, ADJUSTABLE TO FINISHED FLOOR.
GCO	GRADE CLEANOUT	J.R. SMITH 4111	ADJUSTABLE FLOOR CLEANOUT, DURA COATED CAST IRON BODY, WITH EXTRA HEAVY DUTY ROUND SCORIATED SECURED NICKEL BRONZE TOP, ADJUSTABLE TO FINISHED GRADE.
GT-1	GREASE TRAP	J.R. SMITH 8035	INTERCEPTOR WITH MFR FLOW RESTRICTOR FITTING, ACID RESISTANT COATING INSIDE AND OUTSIDE, ALUMINUM COVER.
PROVIDE MO	DEL NUMBERS INDICATED, OR EQU	IIVAI FNT	

PROVIDE MODEL NUMBERS INDICATED, OR EQUIV	ALENT.
---	--------

WATER	HEATERS										
						TEMP	OUTLET	STORAGE	ELEC.	TRICAL	
TAG		AREA		DESIGN	N BASIS	RISE	TEMP	CAPACITY	ELEMENT		
NO.	QUANTITY	SERVED	TYPE	MANUF	MODEL	(DEG F)	(DEG F)	(GAL)	(kW)	VOLTAGE	NOTES
WH-1	1	RESTROOMS	ELECTRIC	AO SMITH	ECRT-80	100	140	80.0	4.5	208-1-60	1,2

1. WATER HEATER TO COMPLY WITH MOST CURRENT VERSIONS OF: NAECA, ASHRAE STD 90.1, AND STATE ENERGY CODE REQUIREMENTS. 2. ELEMENT WATTAGE LISTED IS FOR STANDARD 240 VOLT SINGLE PHASE VOLTAGE; WATTAGE WILL BE DE-RATED FOR 208 VOLT.

UIPMENT REQUIRING ELECTRICAL	_ POWER						
			CW SUPPLY		ELECTRICAL		
DESCRIPTION	DESIGN BASIS	CONN.	BRANCH	AMPS	HP	VOLTAGE	NOTES
INSTANT HOT WATER HEATER	IN-SINK ERATOR, MODEL HOT-1	1/4"		4.3	4000 4000	115	1,2
	DESCRIPTION	DESCRIPTION DESIGN BASIS	DESCRIPTION DESIGN BASIS CONN.	DESCRIPTION DESIGN BASIS CONN. BRANCH	DESCRIPTION DESIGN BASIS CONN. BRANCH AMPS	DESCRIPTION DESIGN BASIS CONN. BRANCH AMPS HP	DESCRIPTION DESIGN BASIS CONN. BRANCH AMPS HP VOLTAGE

1. VERIFY ELECTRICAL VOLTAGE PRIOR TO PLACING ORDER.

2. ADA ACCESSIBLE

PRESSU	JRE REDUC	ING VALVES							
	INLET PI	RESSURE	OUTLET PRESSURE	MAX. FALL-OFF	FLOW				
TAG	MIN	MAX	SETTING	PRESSURE	RATE	SIZE	DESIGN	I BASIS	
NO.	(PSIG)	(PSIG)	(PSIG)	(PSIG)	(GPM)	(IN)	MANUF	MODEL	NOTES
PRV-1	70	140	70	10	58.0	1-1/2"	WATTS	223BS	1

NOTES:
1. PRV TO INCLUDE STRAINER AND THERMAL EXPANSION BY-PASS LINE.

720 NW Davis Suite 300 Portland, OR 97209 Tel. 503.221.1121 Fax. 503.221.2077

maa Munro & **Associates** consulting engineers 18678 SW Boones Ferry Rd Tualatin, Oregon 97062 tel 503.612.6500 fax 503.612.6588

CONSULTANTS


PROJECT NAME

************	***************************************	 	 	

PROJECT: 207037

| DRAWN BY:


Copyright © 2005 LRS Architects, Inc.

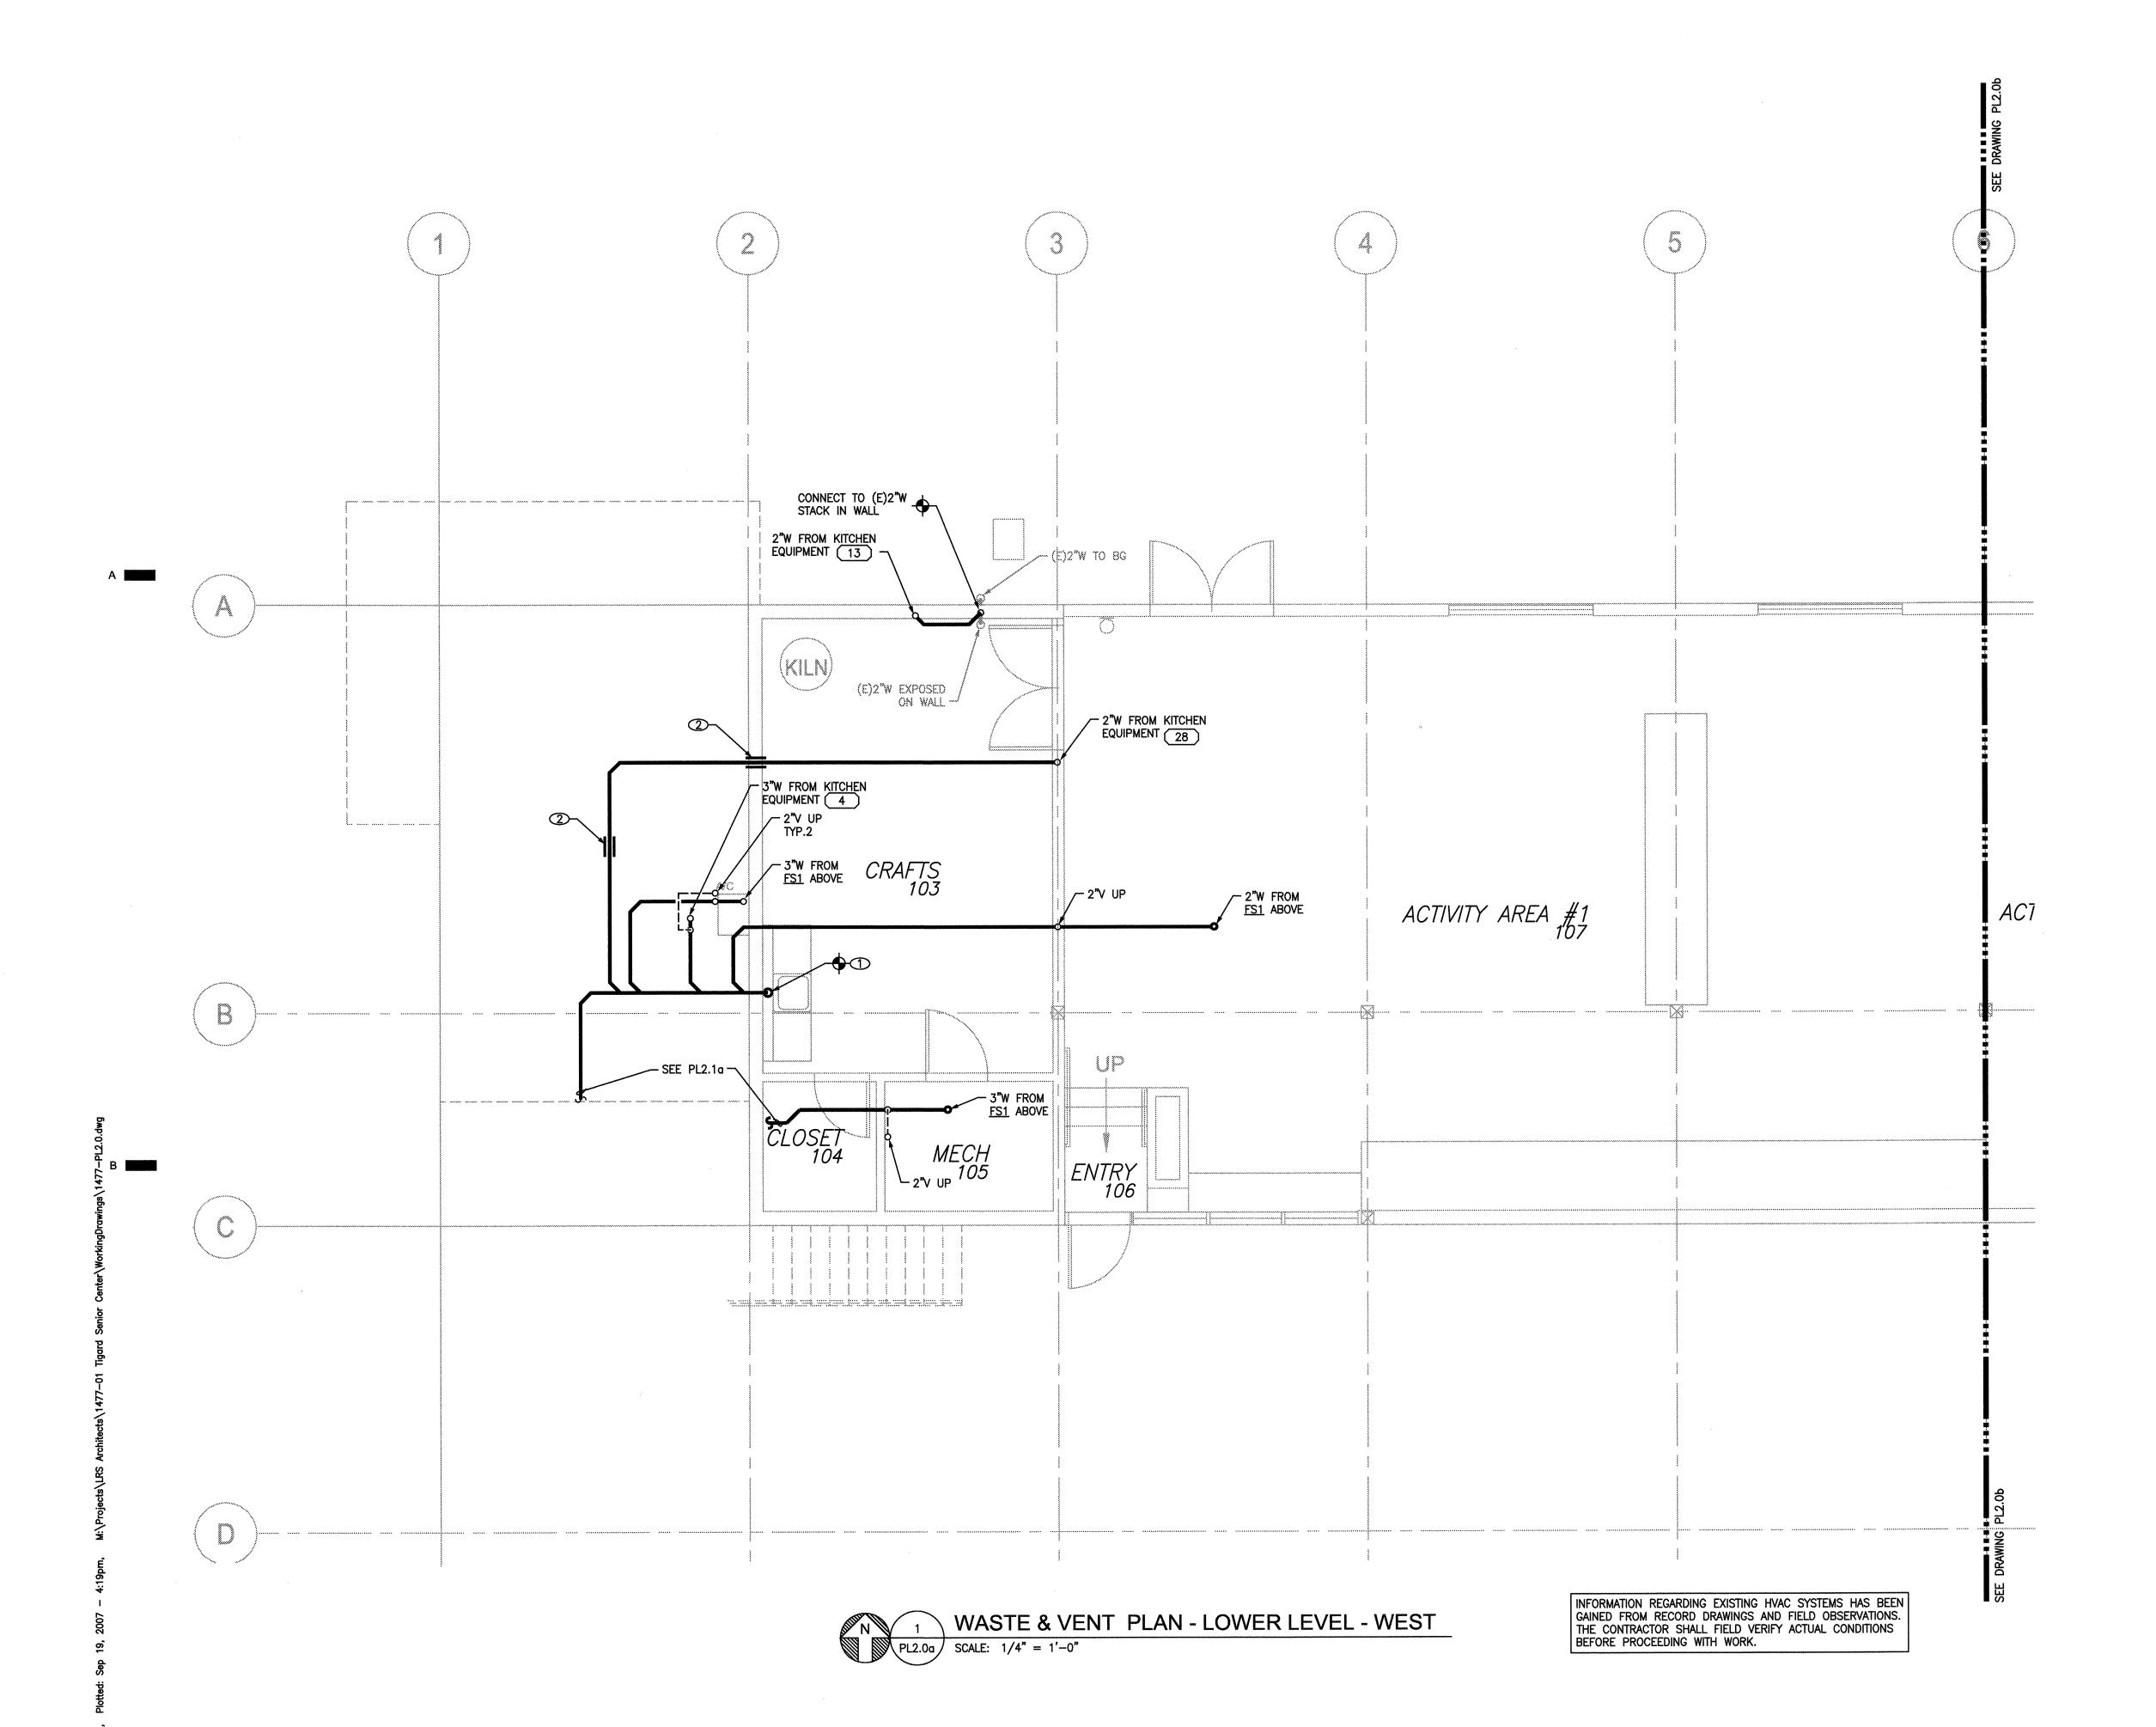

- A. SEE GENERAL PLUMBING NOTES ON DRAWING PLO.
- B. SEE PLUMBING FIXTURE SCHEDULE FOR BRANCH LINE AND CONNECTION SIZES.
- C. SANITARY WASTE SLOPE, UNLESS OTHERWISE NOTED: PIPE SIZES 3" AND LARGER: 1/8" PER FOOT PIPE SIZES 2-1/2" AND SMALLER: 1/4" PER FOOT
- D. SLOPE STORM DRAIN LINES AT 1/8" PER FOOT UNLESS OTHERWISE NOTED.
- E. INVERT ELEVATIONS (I.E.) INDICATED ARE REFERENCED TO A FLOOR FINISHED HEIGHT OF 153.50 FEET. FIELD VERIFY.
- F. PLUMBING VENTS SHALL BE A MINIMUM OF 10 FEET AWAY FROM OUTSIDE AIR INTAKES.
- G. NOT ALL CLEANOUTS ARE SHOWN; CONTRACTOR IS RESPONSIBLE FOR PROVIDING CLEANOUTS IN ACCORDANCE WITH THE CODE; COORDINATE LOCATIONS OF CLEANOUTS WITH GC/OWNER REPRESENTATIVE.
- H. PROVIDE TRAP PRIMERS AT ALL FLOOR DRAINS, UNLESS OTHERWISE NOTED.
- I. PROVIDE FIRESTOPPING, SLEEVES, AND SEALANTS AT FLOOR, WALL, AND CEILING PENETRATIONS; COORDINATE LOCATIONS WITH GC.

KEYED NOTES

- ① CONNECT TO (E)3"W STACK IN (E) PLUMBING CHASE.
- CORE THRU (E) CONCRETE STEM WALLS. COORDINATE WITH STRUCTURAL.

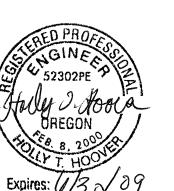

LRS a

720 NW Davis Suite 300 Portland, OR 97209 Tel. 503.221.1121 Fax. 503.221.2077

503.221.2077

Munro & Associates consulting engineers

18678 SW Boones Ferry Rd Tualatin, Oregon 97062 tel 503.612.6500 fax 503.612.6588

CONSULTANTS


ENTER DDITION F. 223 PLAN

ARD SENIOR CENTONAND ADD 8815 SW O'MARA ST.
TIGARD, OREGON 97223


PROJECT NAME


CHECK:

PROJECT: 20703

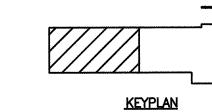


PL2.0a

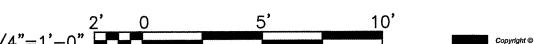

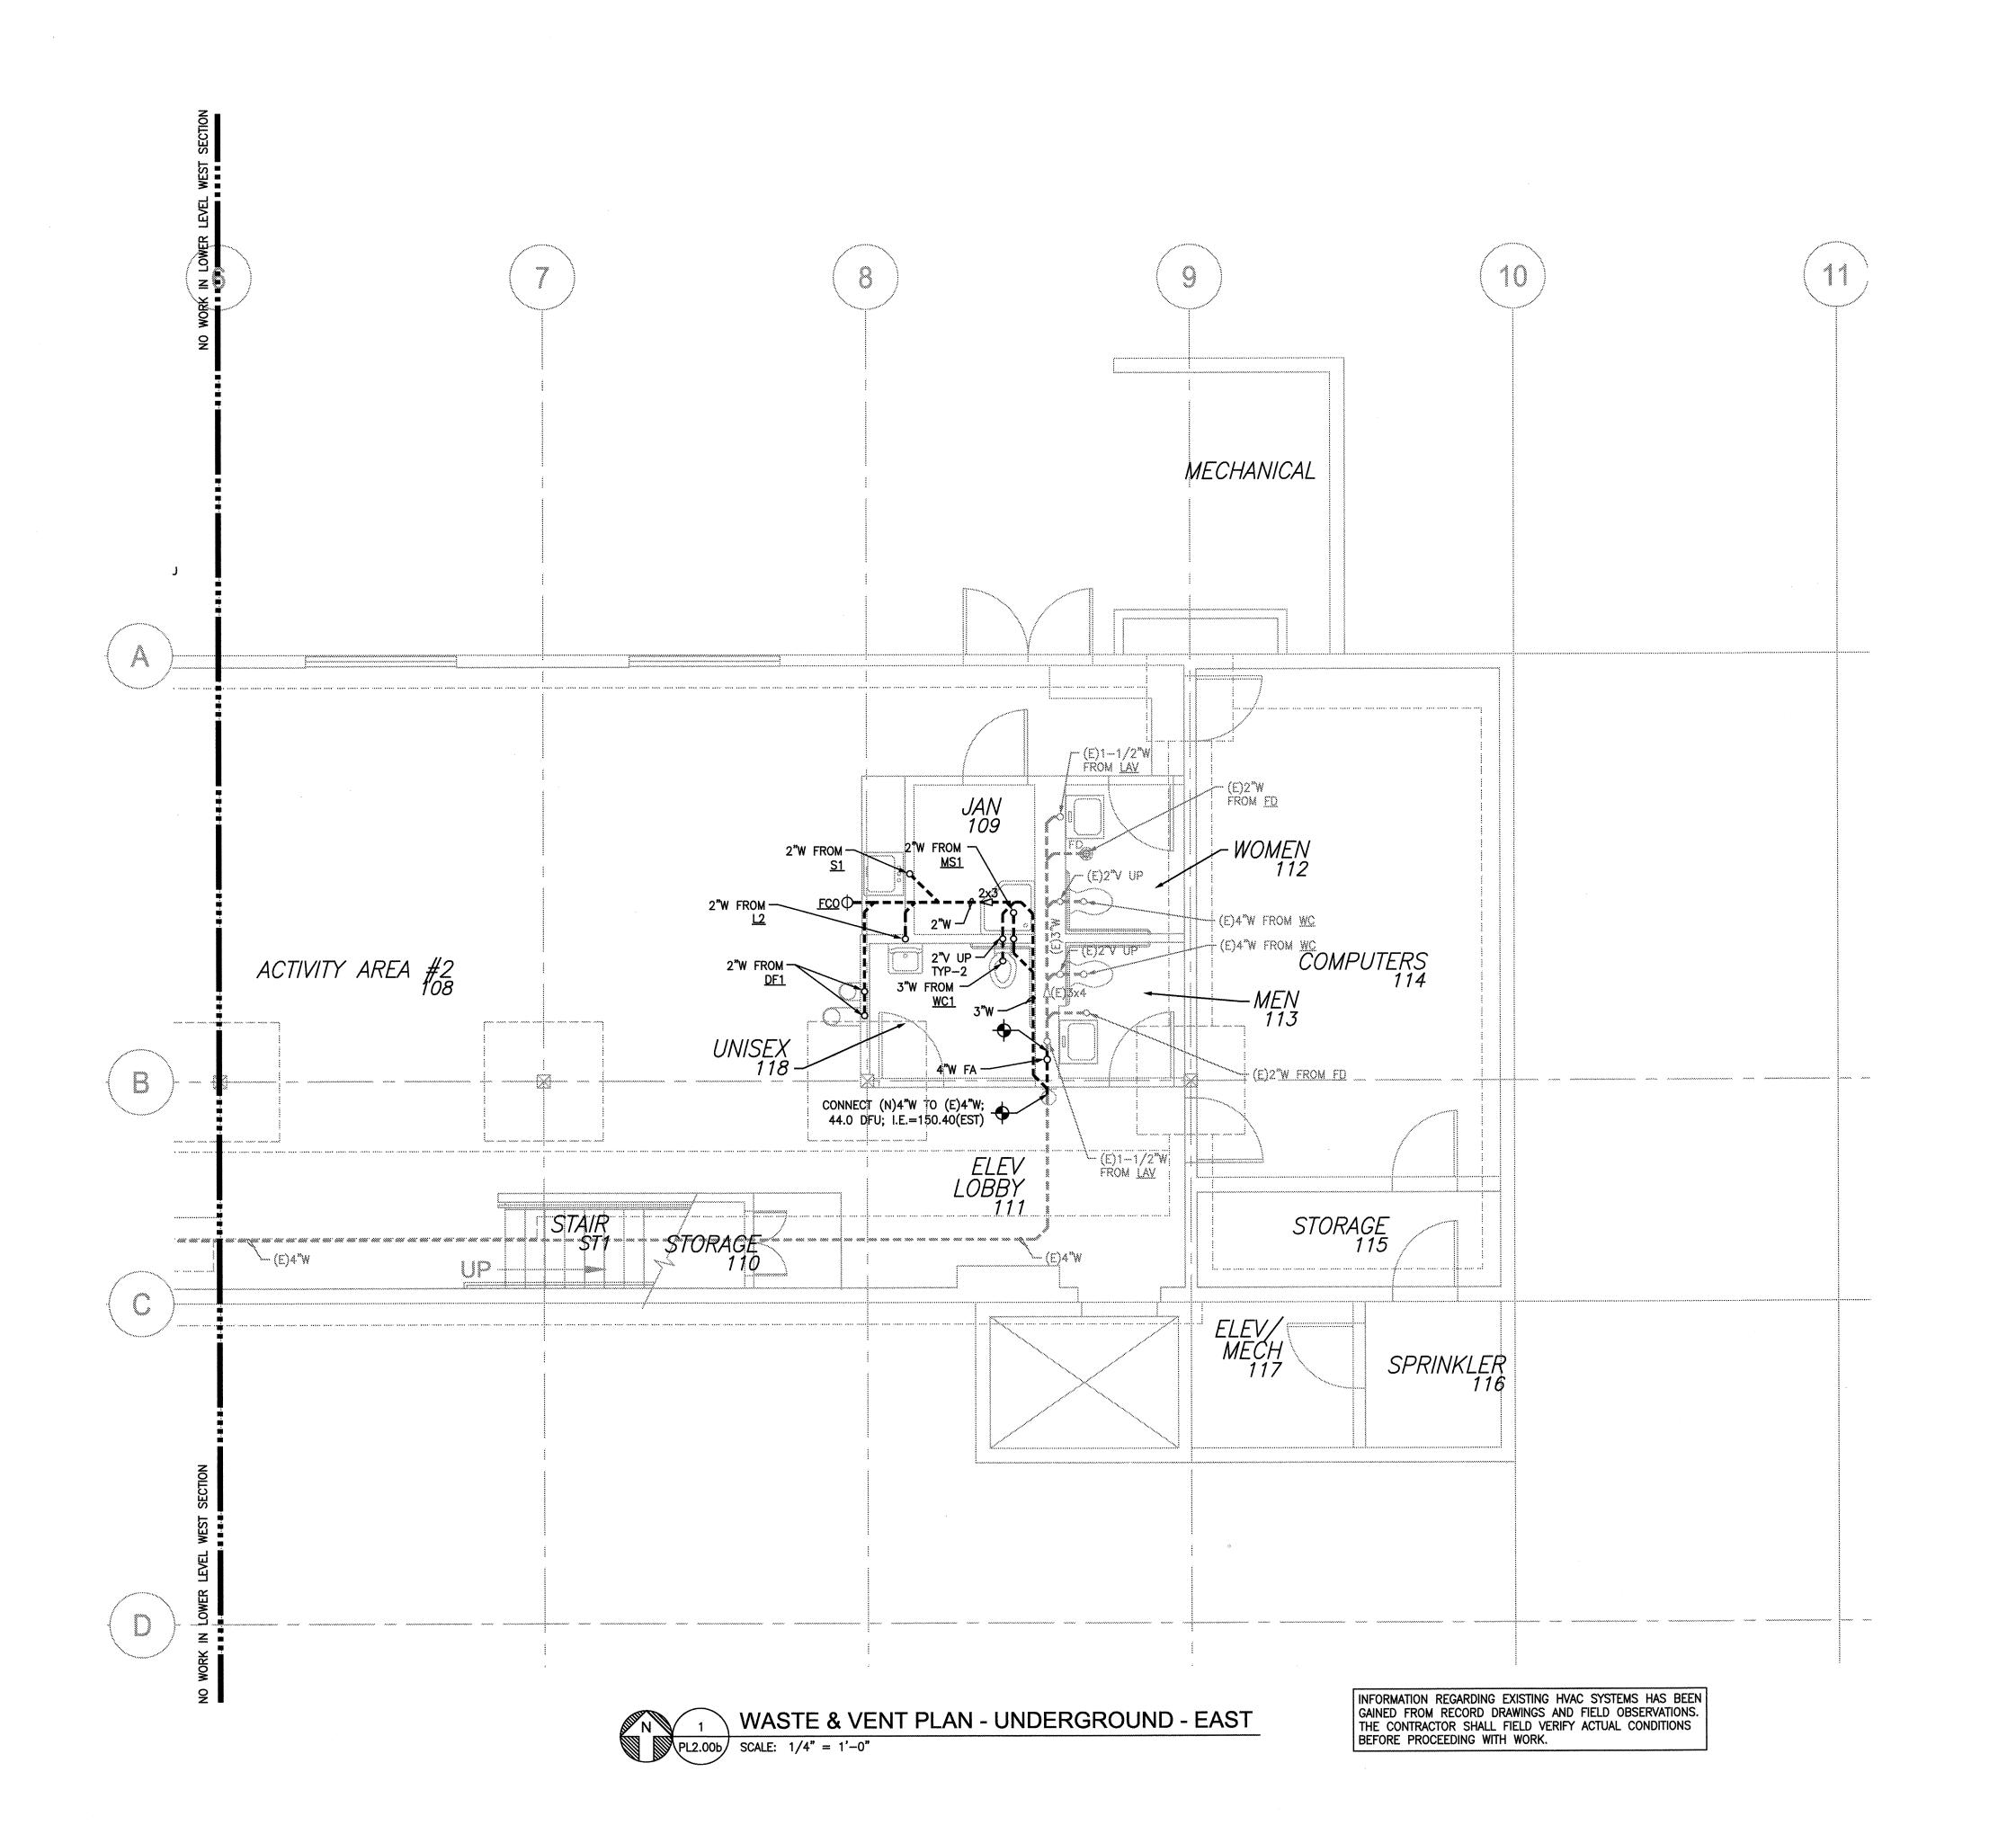

OTHERWISE NOTED.

- A. SEE GENERAL PLUMBING NOTES ON DRAWING PLO.
- B. SEE PLUMBING FIXTURE SCHEDULE FOR BRANCH LINE AND CONNECTION SIZES.
- C. SANITARY WASTE SLOPE, UNLESS OTHERWISE NOTED: PIPE SIZES 3" AND LARGER: 1/8" PER FOOT PIPE SIZES 2-1/2" AND SMALLER: 1/4" PER FOOT
- D. SLOPE STORM DRAIN LINES AT 1/8" PER FOOT UNLESS
- E. INVERT ELEVATIONS (I.E.) INDICATED ARE REFERENCED TO A FLOOR FINISHED HEIGHT OF 153.50 FEET. FIELD VERIFY.
- F. PLUMBING VENTS SHALL BE A MINIMUM OF 10 FEET AWAY FROM OUTSIDE AIR INTAKES.
- G. NOT ALL CLEANOUTS ARE SHOWN; CONTRACTOR IS RESPONSIBLE FOR PROVIDING CLEANOUTS IN ACCORDANCE WITH THE CODE; COORDINATE LOCATIONS OF CLEANOUTS WITH GC/OWNER REPRESENTATIVE.
- H. PROVIDE TRAP PRIMERS AT ALL FLOOR DRAINS, UNLESS OTHERWISE NOTED.
- I. PROVIDE FIRESTOPPING, SLEEVES, AND SEALANTS AT FLOOR, WALL, AND CEILING PENETRATIONS; COORDINATE LOCATIONS WITH GC.

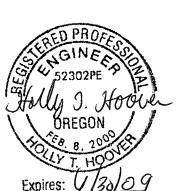

LRS a

720 NW Davis
Suite 300

Portland, OR 97209 Tel. 503.221.1121 Fax. 503.221.2077

Munro & Associates consulting engineers

18678 SW Boones Ferry Rd Tualatin, Oregon 97062

tel 503.612.6500

fax 503.612.6588

CONSULTANTS

IGARD SENIOR CENTER
VOVATION AND ADDITION
8815 SW O'MARA ST.
TIGARD, OREGON 97223
VASTE & VENT PLAN


PROJECT NAME

DATE: 09.20.0

CHECK:


DRAWN BY:

PROJECT: 207037

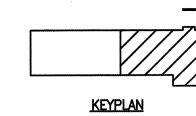

PL2.00b



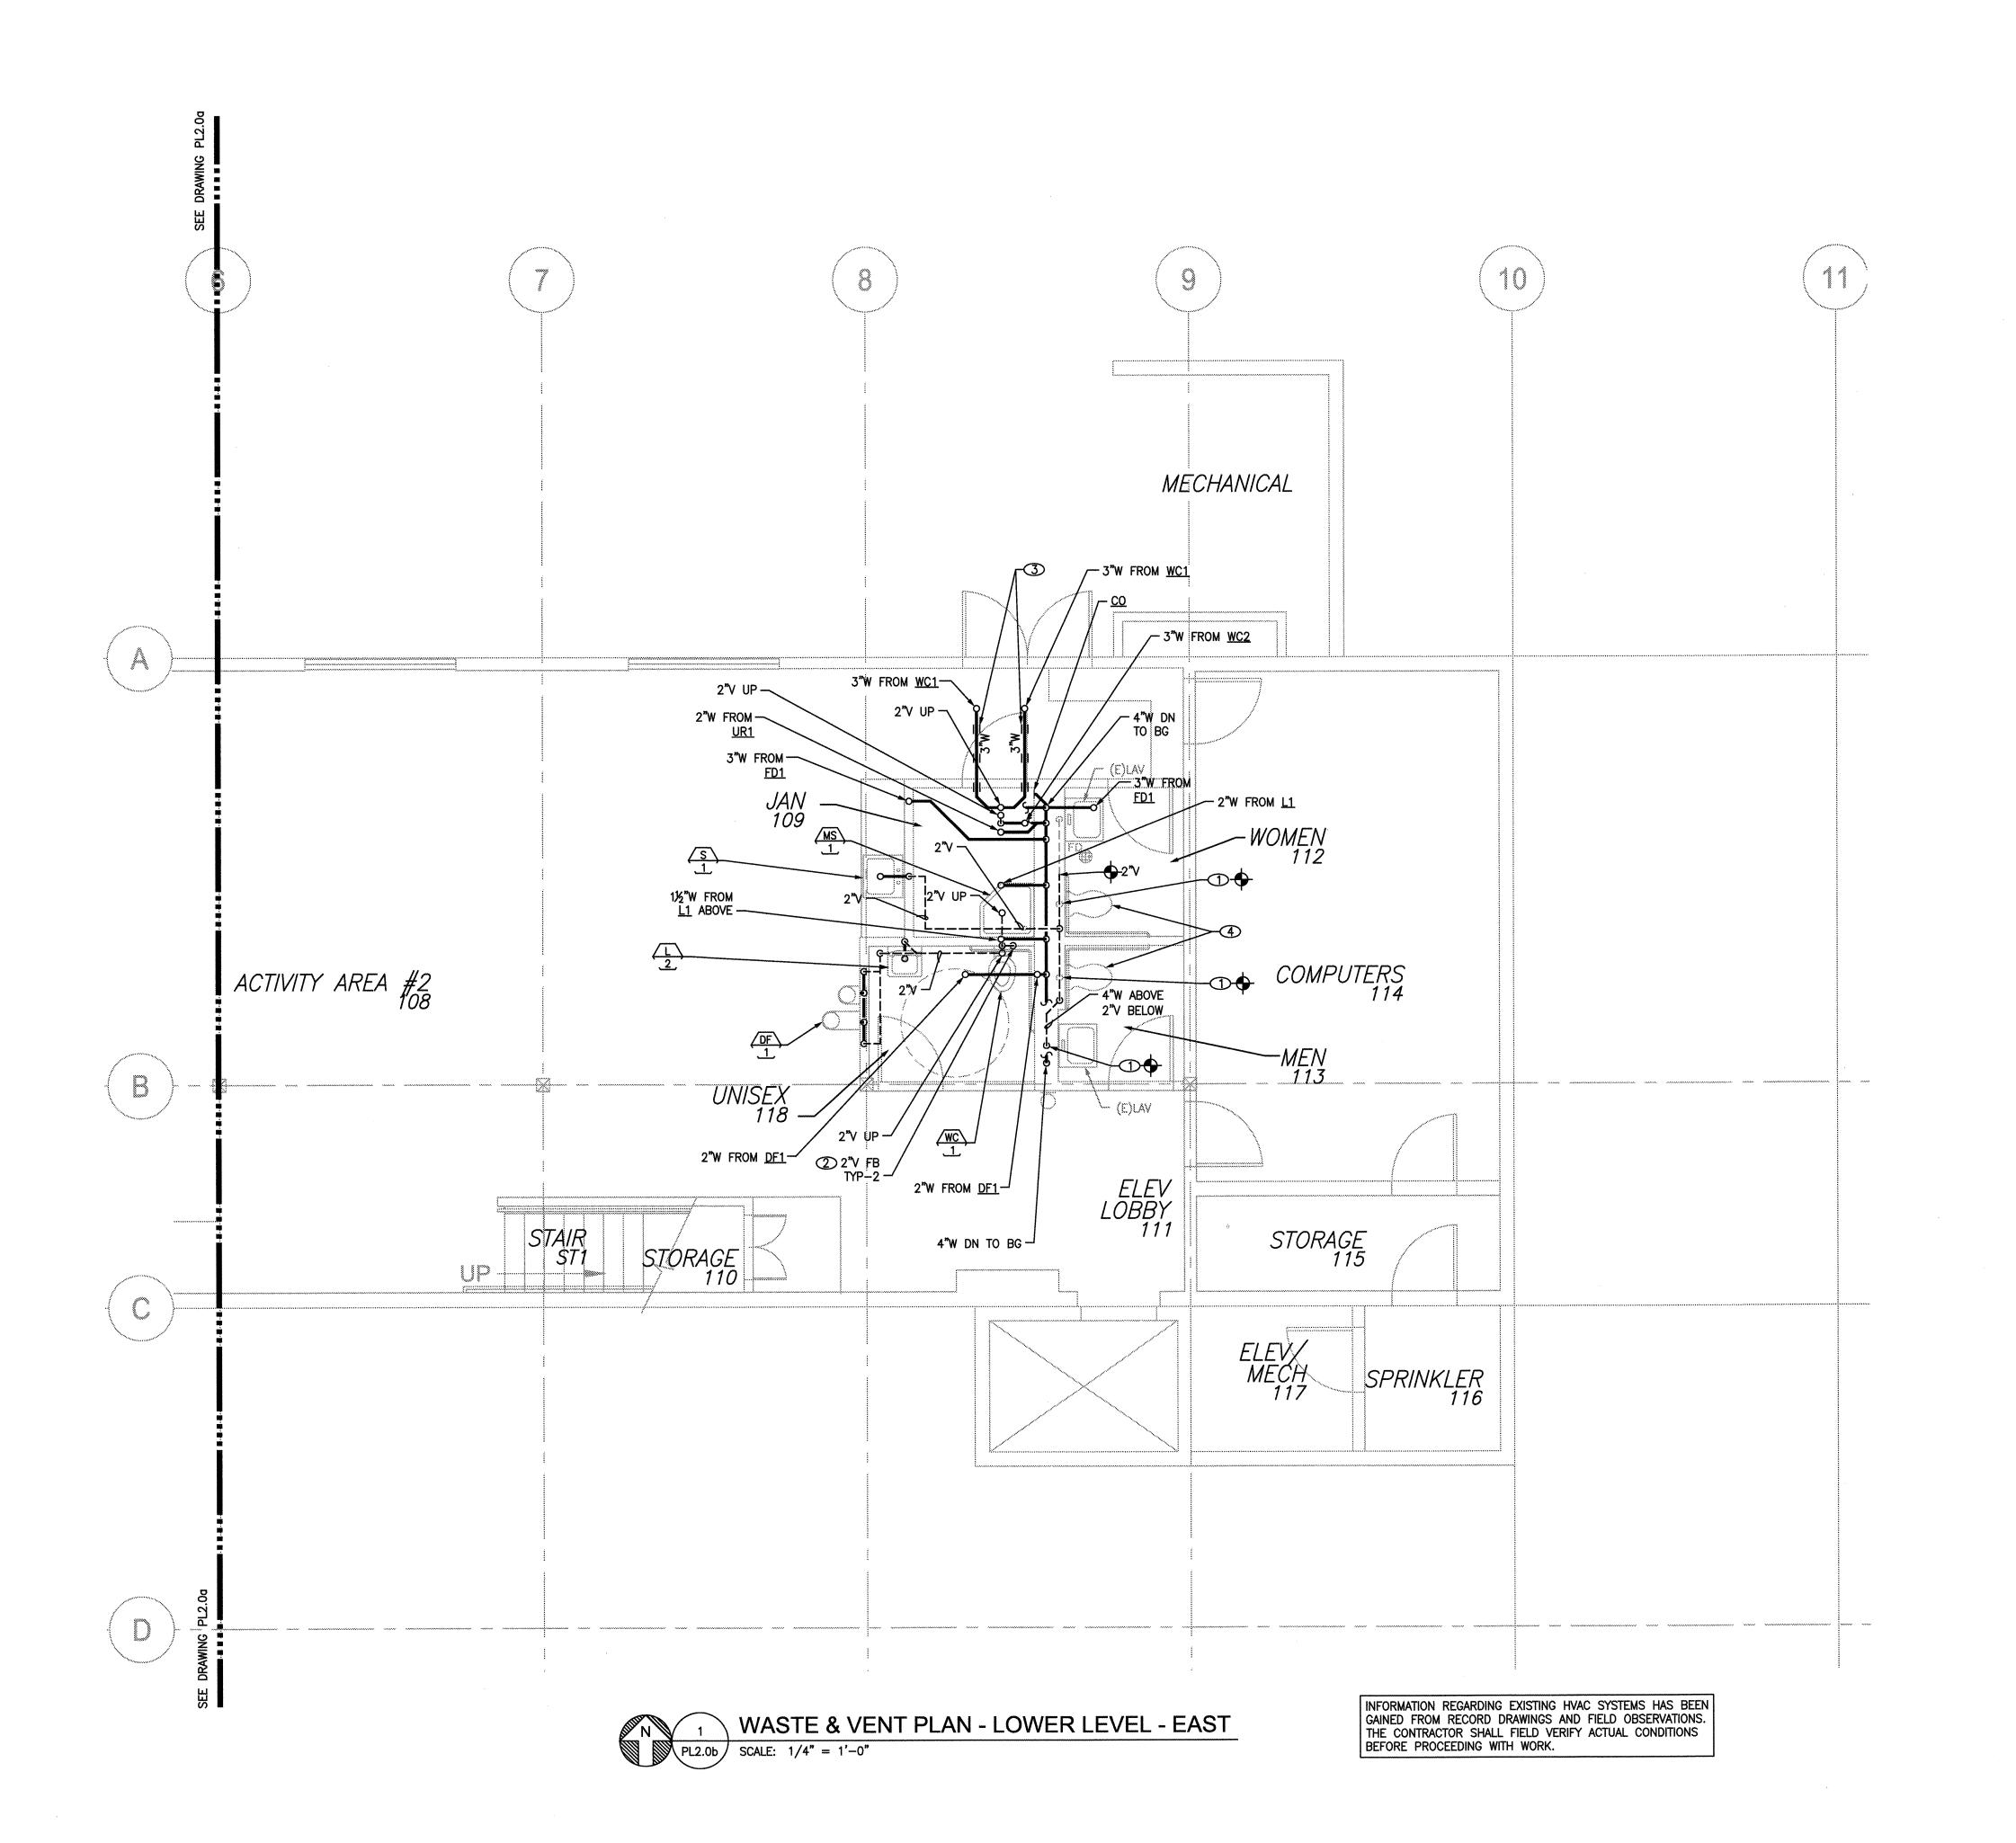

- A. SEE GENERAL PLUMBING NOTES ON DRAWING PLO.
 B. SEE PLUMBING FIXTURE SCHEDULE FOR BRANCH LINE AND CONNECTION SIZES.
- C. SANITARY WASTE SLOPE, UNLESS OTHERWISE NOTED: PIPE SIZES 3" AND LARGER: 1/8" PER FOOT PIPE SIZES 2-1/2" AND SMALLER: 1/4" PER FOOT
- D. SLOPE STORM DRAIN LINES AT 1/8" PER FOOT UNLESS OTHERWISE NOTED.
- E. INVERT ELEVATIONS (I.E.) INDICATED ARE REFERENCED TO A FLOOR FINISHED HEIGHT OF 153.50 FEET. FIELD VERIFY.
- FLOOR FINISHED HEIGHT OF 153.50 FEET. FIELD VERIFY.


 F. PLUMBING VENTS SHALL BE A MINIMUM OF 10 FEET AWAY FROM
- OUTSIDE AIR INTAKES.

 G. NOT ALL CLEANOUTS ARE SHOWN; CONTRACTOR IS RESPONSIBLE FOR PROVIDING CLEANOUTS IN ACCORDANCE WITH THE CODE; COORDINATE LOCATIONS OF CLEANOUTS WITH GC/OWNER
- H. PROVIDE TRAP PRIMERS AT ALL FLOOR DRAINS, UNLESS OTHERWISE NOTED.
- I. PROVIDE FIRESTOPPING, SLEEVES, AND SEALANTS AT FLOOR, WALL, AND CEILING PENETRATIONS; COORDINATE LOCATIONS WITH GC.

KEYED NOTES

REPRESENTATIVE.

- ONNECT (N)2"V TO (E)2"V STACK SERVING FIXTURE.
- OFFSET IN WALL.
- 3 PENETRATE THRU JOIST. SEE STRUCTURAL DWGS. TYP. 6
- 4 REINSTALL (E)WC AFTER FLOORING COMPLETE.

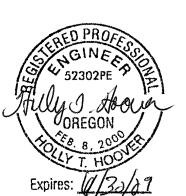

L R S a

Davis

720 NW Davis Suite 300 Portland, OR 97209 Tel. 503.221.1121 Fax. 503.221.2077

Munro & Associates consulting engineers

18678 SW Boones Ferry Rd Tualatin, Oregon 97062 tel 503.612.6500 fax 503.612.6588

CONSULTANTS

TIGARD SENIOR CENTER
RENOVATION AND ADDITIO
8815 SW O'MARA ST.
TIGARD, OREGON 97223
WASTE & VENT PLAN
LOWER LEVEL - EAST


PROJECT	NAM

	 	,	
***************************************	 		********


TE: 09.20.07


CHECK: L

PROJECT: 2070

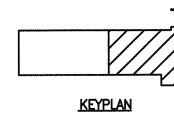


PL2.0b

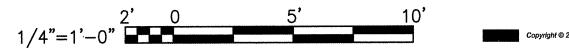

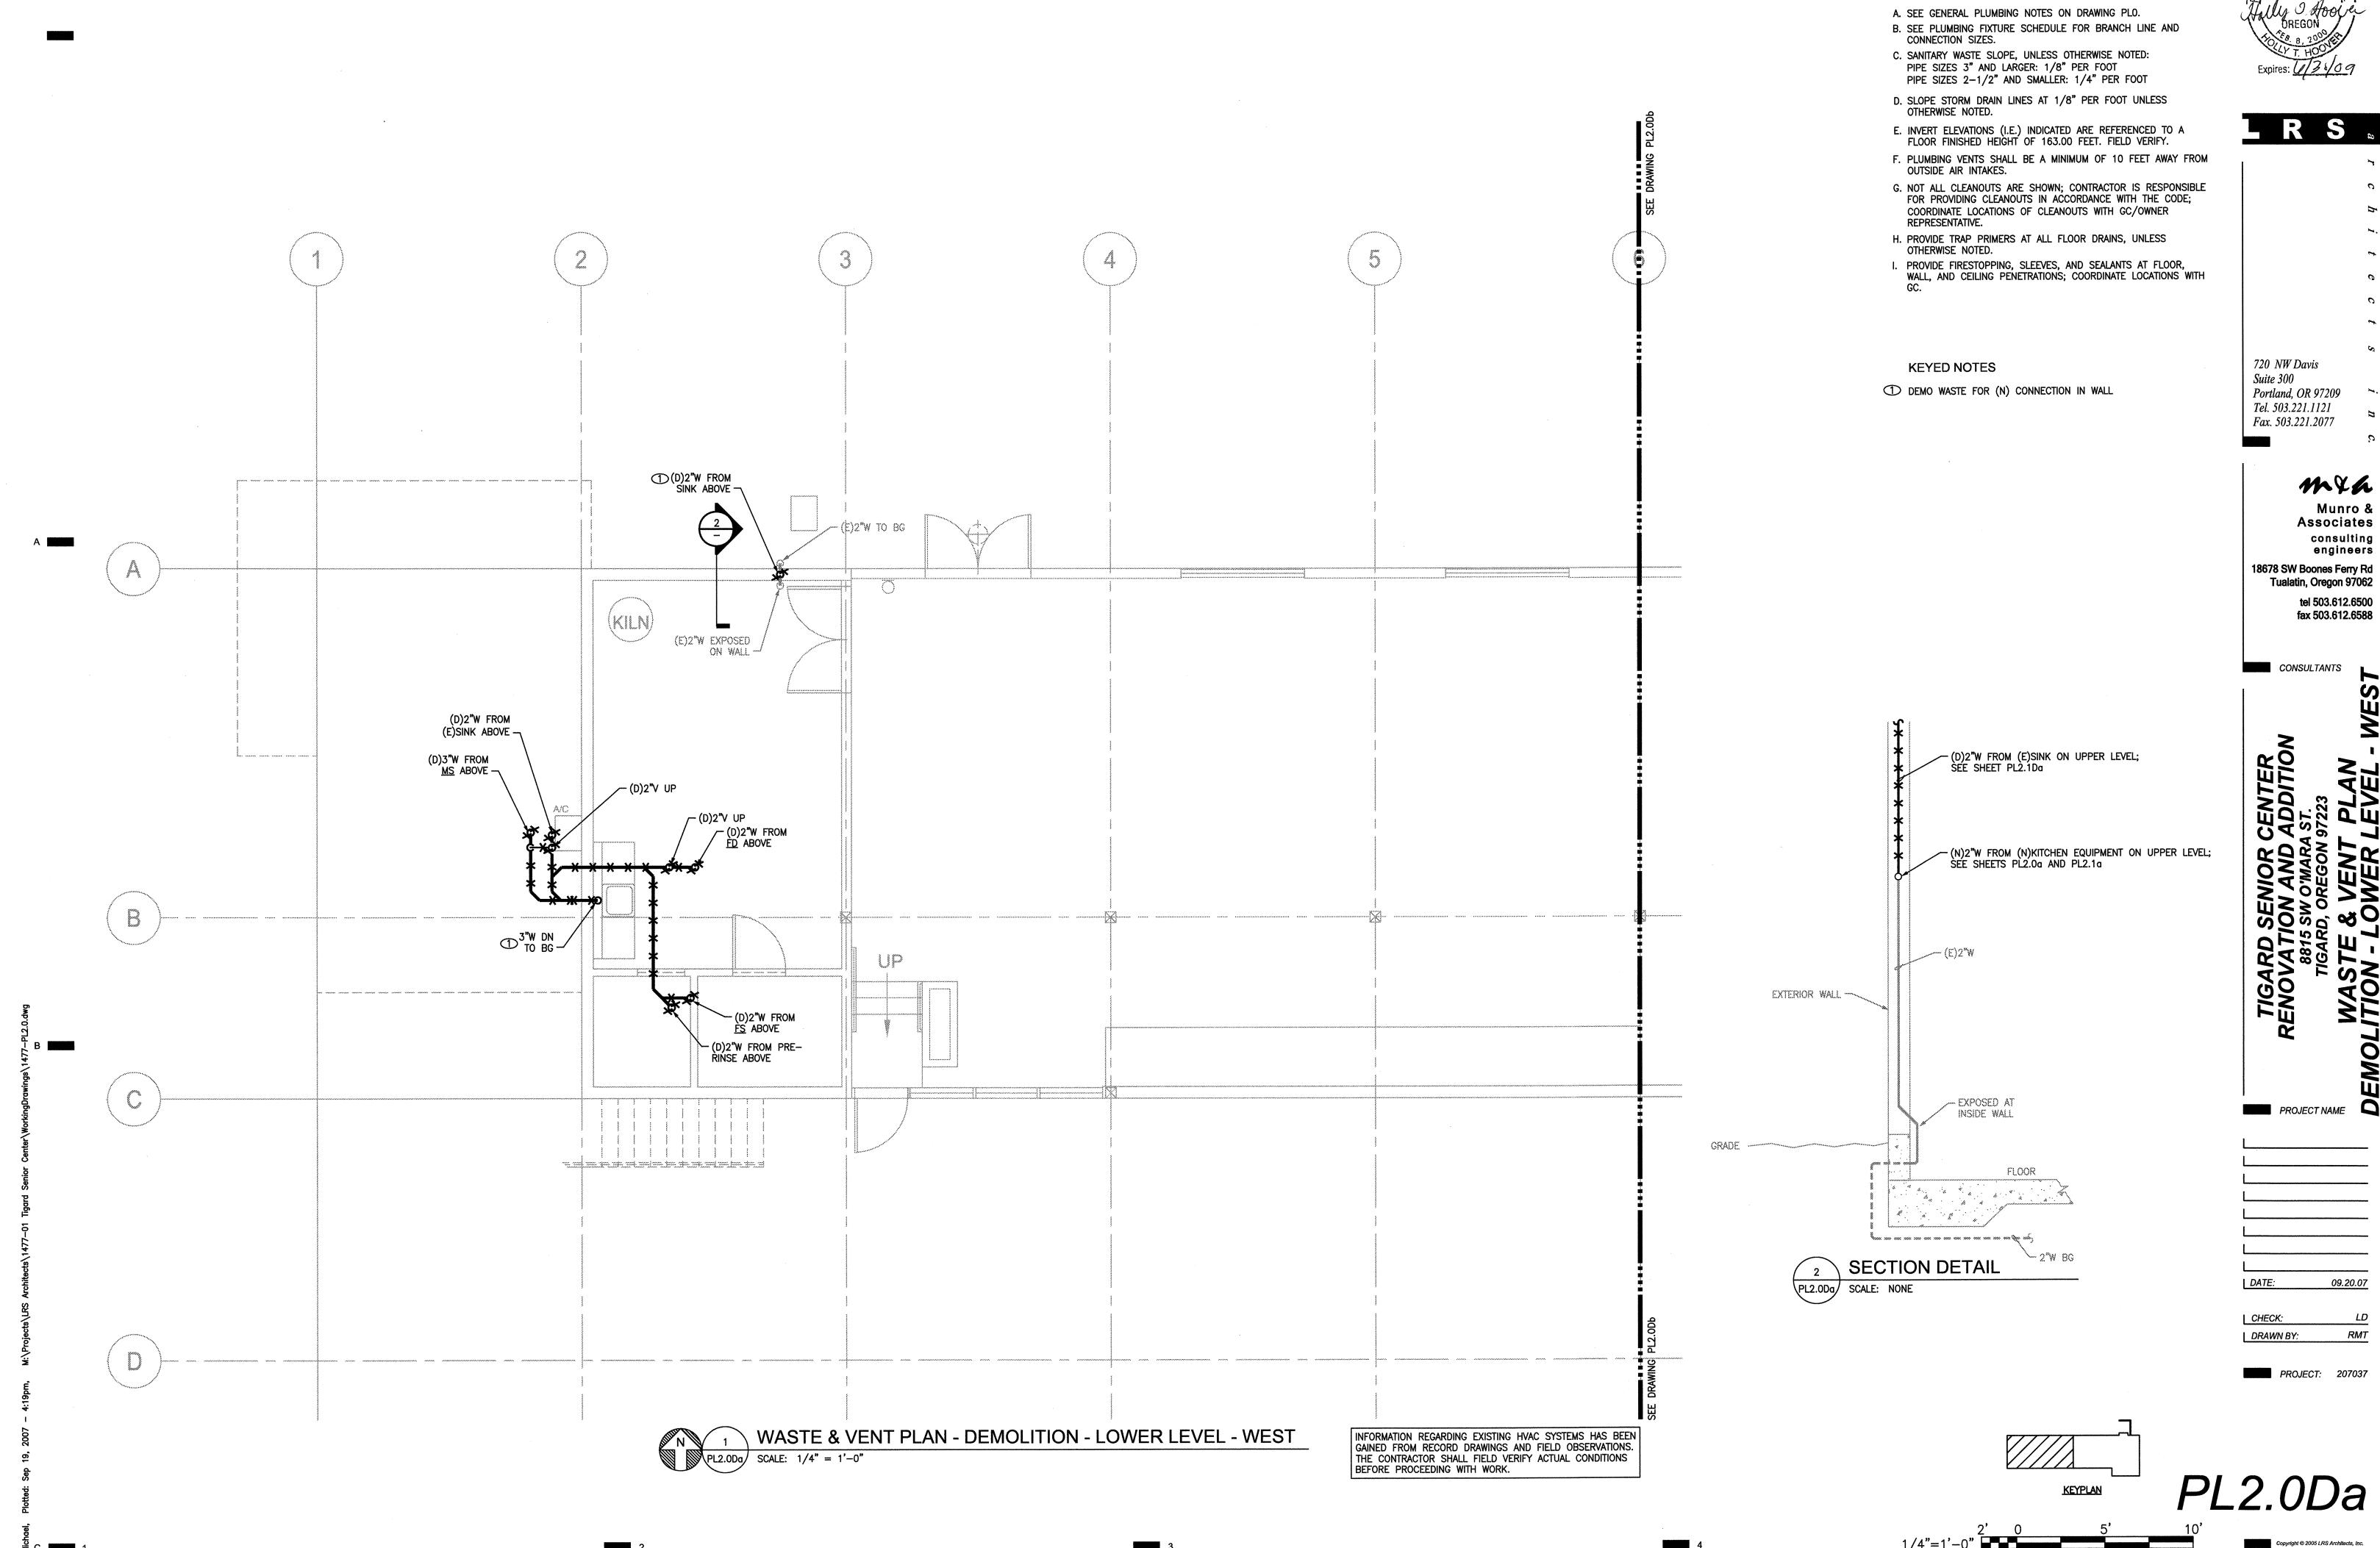

tel 503.612.6500 fax 503.612.6588

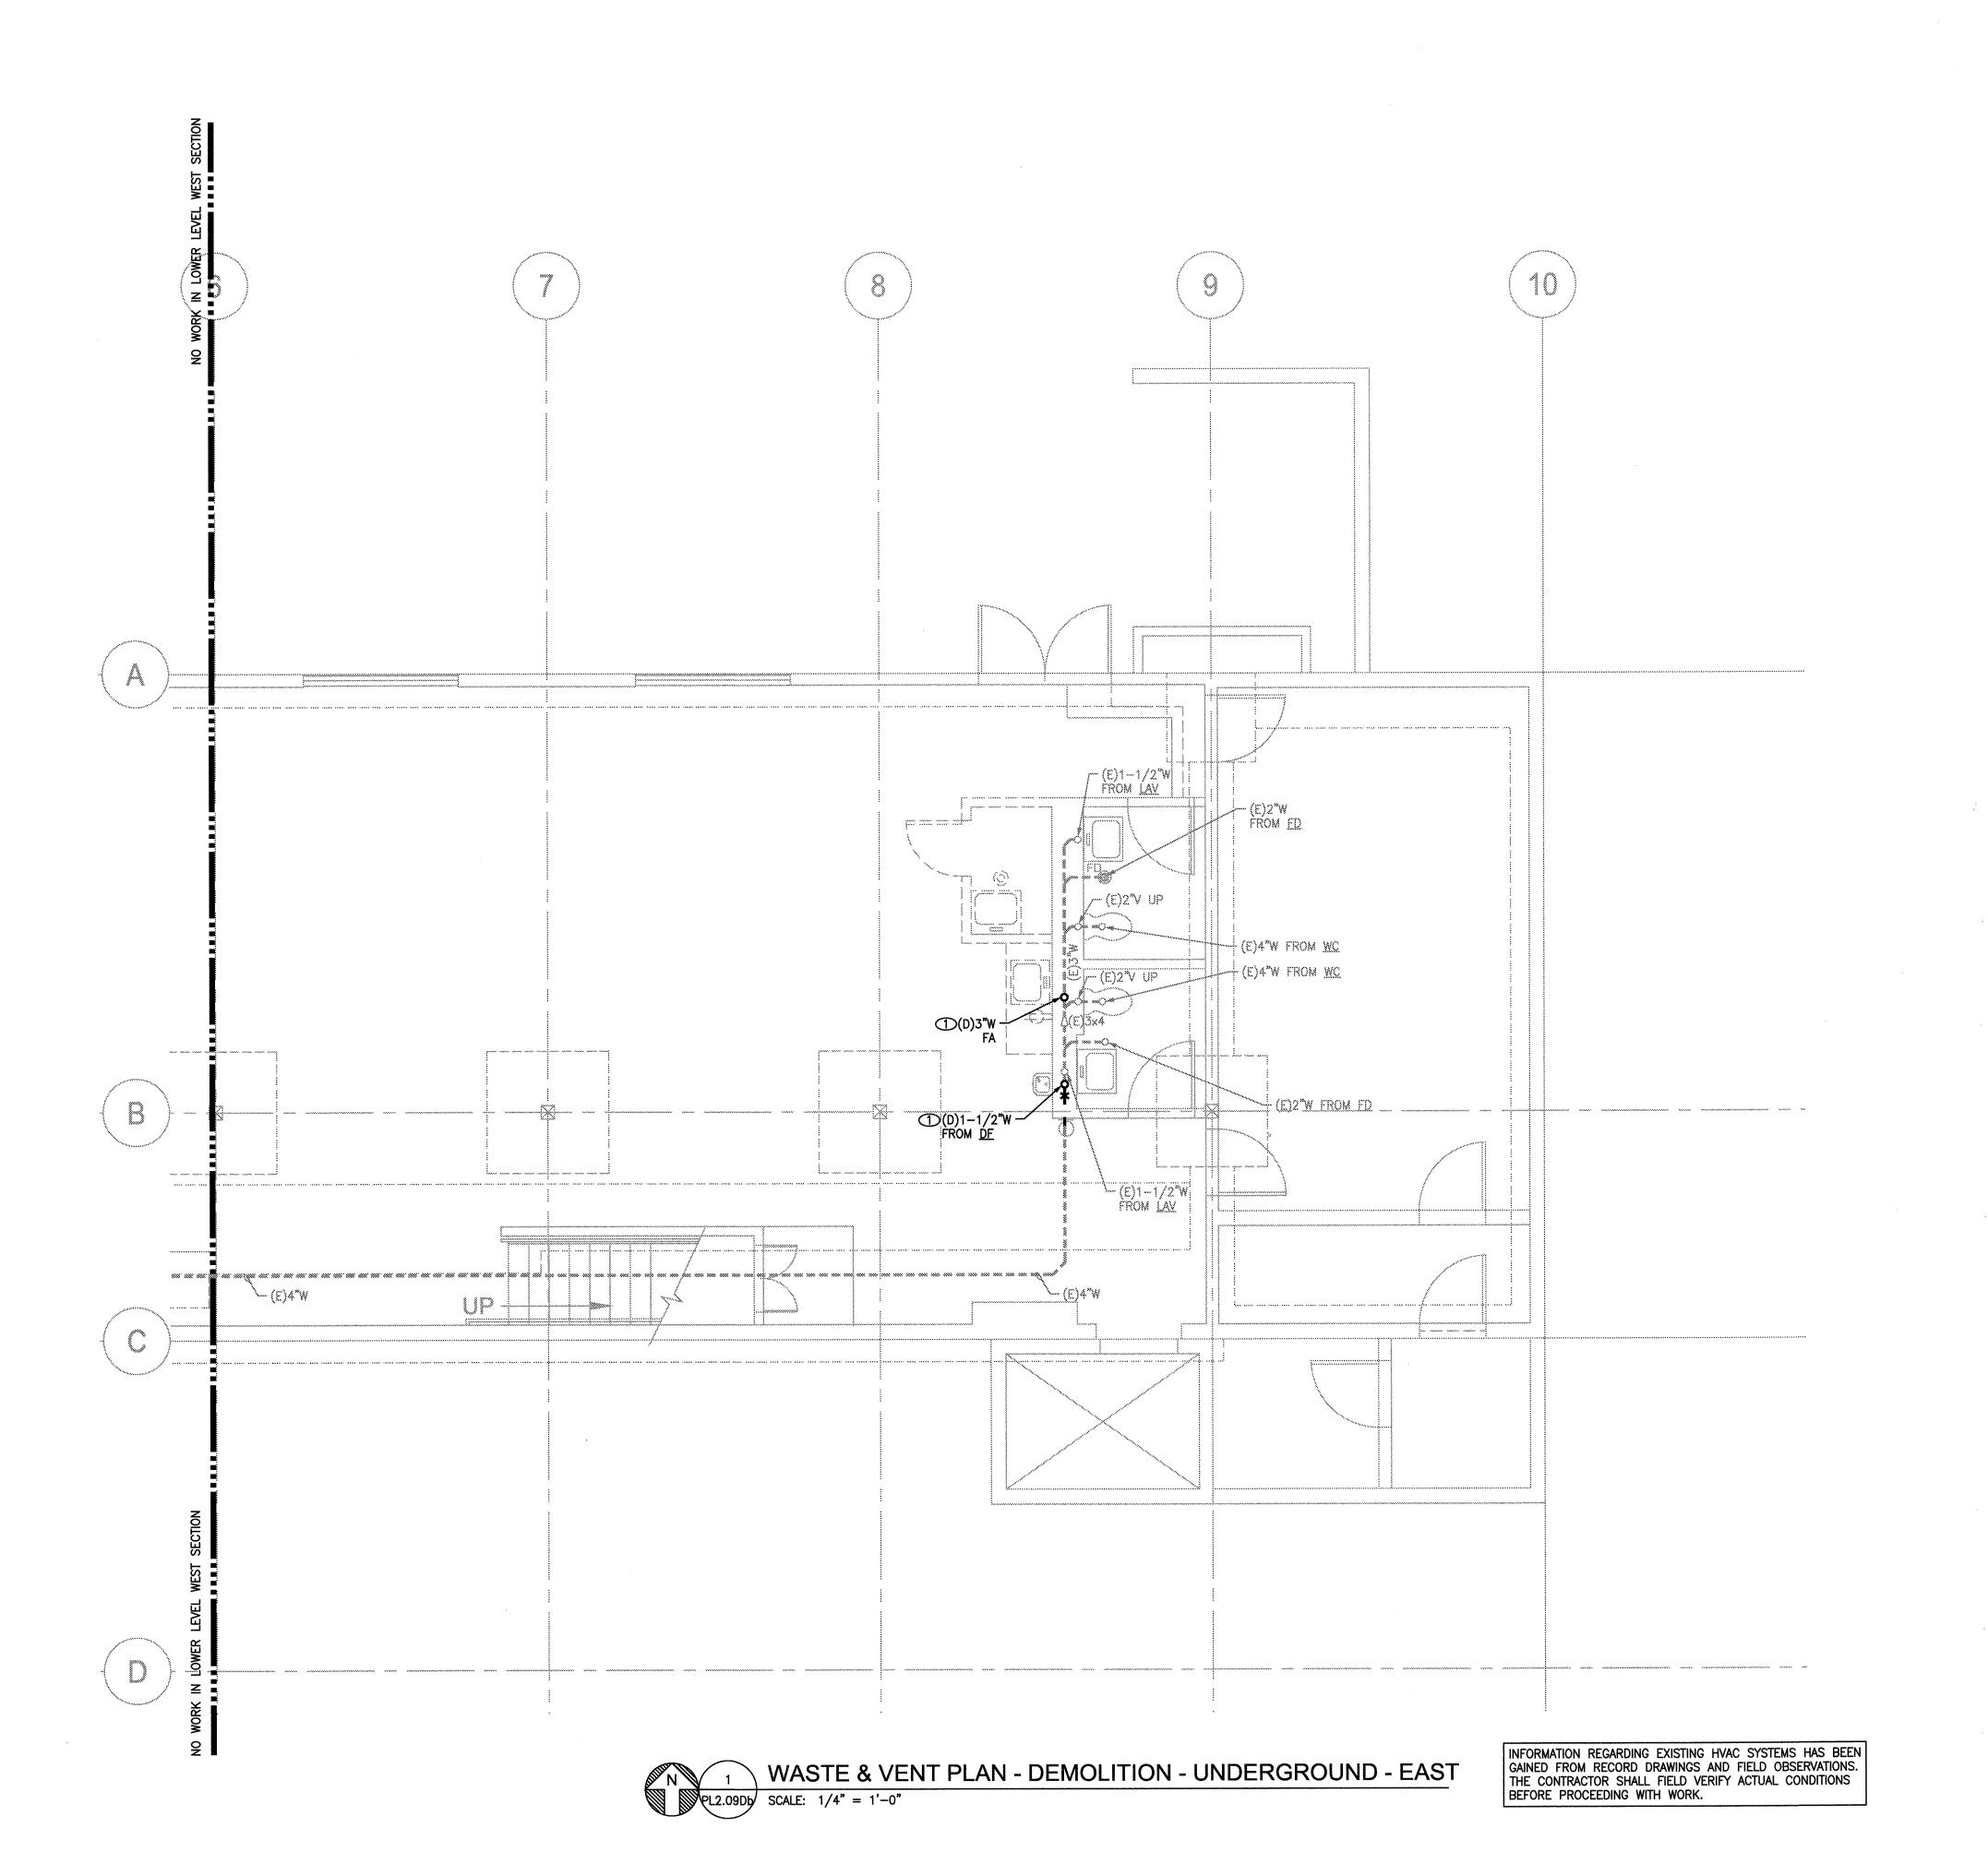

- A. SEE GENERAL PLUMBING NOTES ON DRAWING PLO.
 B. SEE PLUMBING FIXTURE SCHEDULE FOR BRANCH LINE AND
- SEE PLUMBING FIXTURE SCHEDULE FO CONNECTION SIZES.
- C. SANITARY WASTE SLOPE, UNLESS OTHERWISE NOTED: PIPE SIZES 3" AND LARGER: 1/8" PER FOOT PIPE SIZES 2-1/2" AND SMALLER: 1/4" PER FOOT
- D. SLOPE STORM DRAIN LINES AT 1/8" PER FOOT UNLESS OTHERWISE NOTED.
- E. INVERT ELEVATIONS (I.E.) INDICATED ARE REFERENCED TO A FLOOR FINISHED HEIGHT OF 153.50 FEET. FIELD VERIFY.
- F. PLUMBING VENTS SHALL BE A MINIMUM OF 10 FEET AWAY FROM OUTSIDE AIR INTAKES.
- G. NOT ALL CLEANOUTS ARE SHOWN; CONTRACTOR IS RESPONSIBLE FOR PROVIDING CLEANOUTS IN ACCORDANCE WITH THE CODE; COORDINATE LOCATIONS OF CLEANOUTS WITH GC/OWNER REPRESENTATIVE.
- H. PROVIDE TRAP PRIMERS AT ALL FLOOR DRAINS, UNLESS OTHERWISE NOTED.
- I. PROVIDE FIRESTOPPING, SLEEVES, AND SEALANTS AT FLOOR, WALL, AND CEILING PENETRATIONS; COORDINATE LOCATIONS WITH

KEYED NOTES

① DEMO AND CAP WASTE BRANCH AT A POINT TO BE CONCEALED BY FINISH WORK.



LRS a

720 NW Davis Suite 300 Portland, OR 97209 Tel. 503.221.1121 Fax. 503.221.2077

mya

Munro & Associates consulting engineers

18678 SW Boones Ferry Rd Tualatin, Oregon 97062 tel 503.612.6500 fax 503.612.6588

CONSULTANTS

CONSULTANT

ENIOR CENTER
N AND ADDITION
NOTIVER ST.
OREGON 97223

TIGARI ENOVA 88 116, WAST

PPO JECT NAME

TE: 09.20.07


CHECK:

DRAWN BY: RI

PROJECT: 20703




2' 0 5' 10'
1/4"=1'-0" Copyright © 20

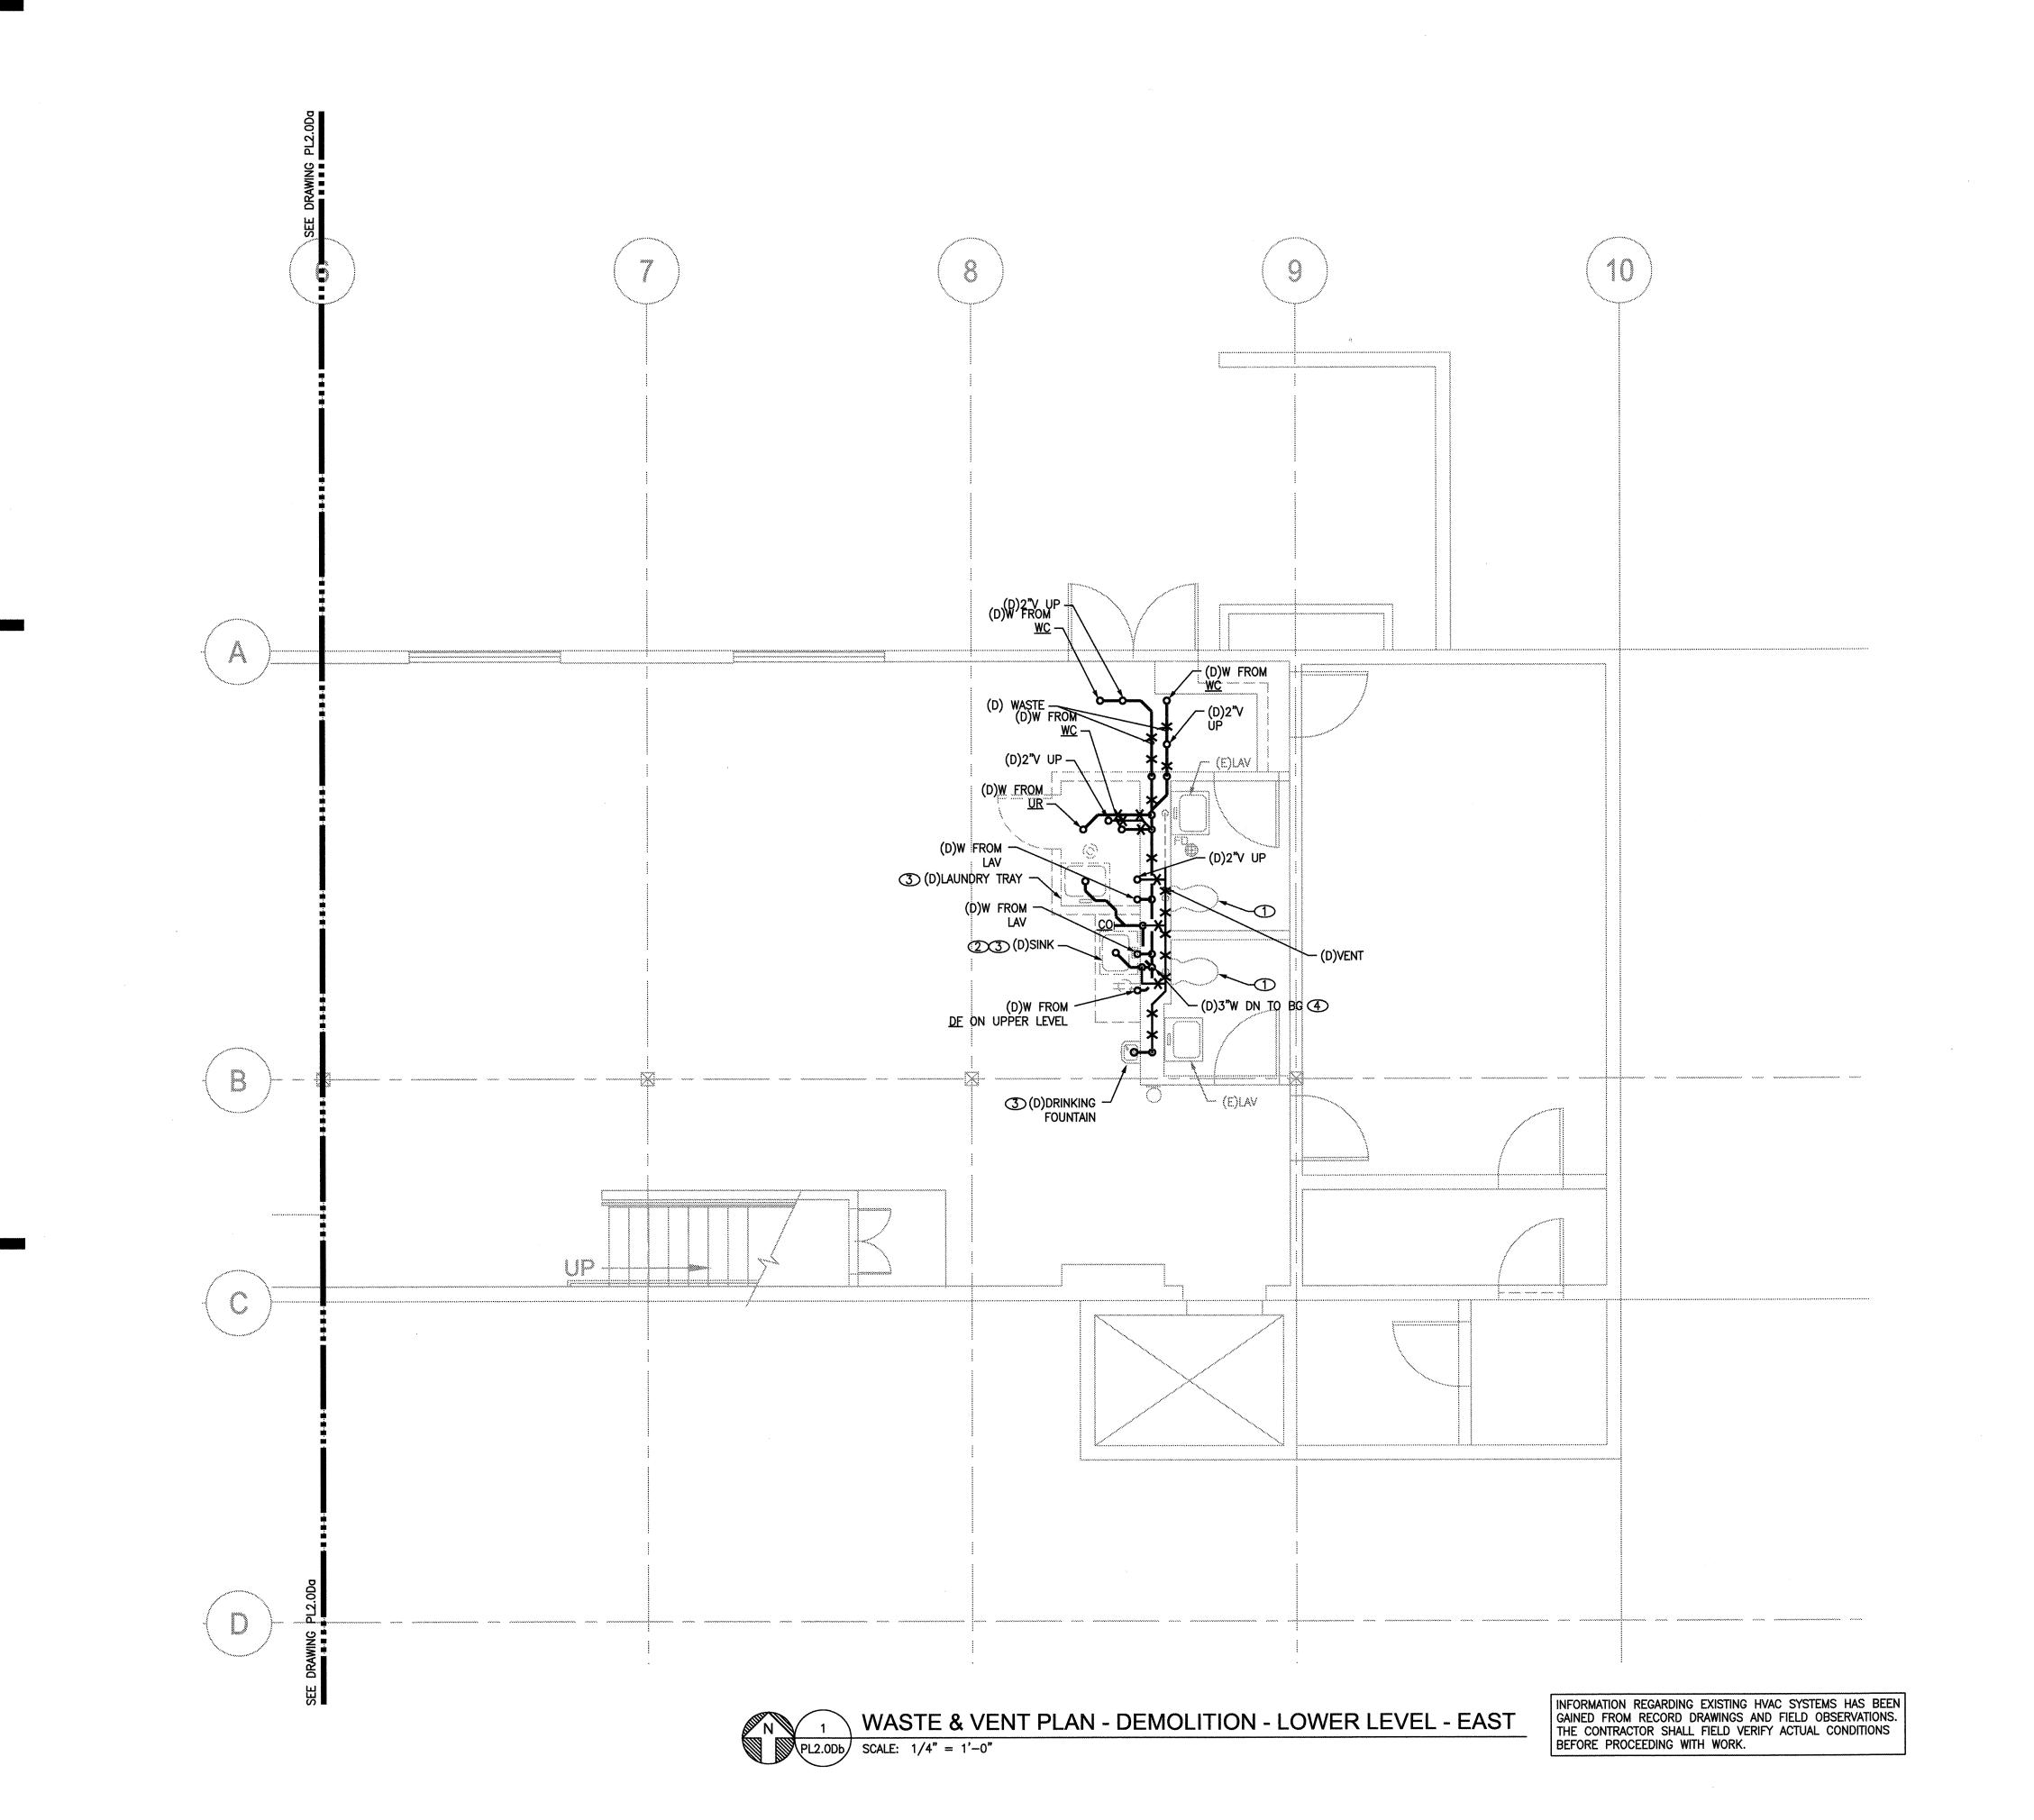

- A. SEE GENERAL PLUMBING NOTES ON DRAWING PLO.
 B. SEE PLUMBING FIXTURE SCHEDULE FOR BRANCH LINE AND
- SEE PLUMBING FIXTURE SCHEDULE FOR BRANCH LINE A CONNECTION SIZES.
- C. SANITARY WASTE SLOPE, UNLESS OTHERWISE NOTED: PIPE SIZES 3" AND LARGER: 1/8" PER FOOT PIPE SIZES 2-1/2" AND SMALLER: 1/4" PER FOOT
- D. SLOPE STORM DRAIN LINES AT 1/8" PER FOOT UNLESS OTHERWISE NOTED.
- E. INVERT ELEVATIONS (I.E.) INDICATED ARE REFERENCED TO A FLOOR FINISHED HEIGHT OF 153.50 FEET. FIELD VERIFY.
- F. PLUMBING VENTS SHALL BE A MINIMUM OF 10 FEET AWAY FROM OUTSIDE AIR INTAKES.
- G. NOT ALL CLEANOUTS ARE SHOWN; CONTRACTOR IS RESPONSIBLE FOR PROVIDING CLEANOUTS IN ACCORDANCE WITH THE CODE; COORDINATE LOCATIONS OF CLEANOUTS WITH GC/OWNER REPRESENTATIVE.
- H. PROVIDE TRAP PRIMERS AT ALL FLOOR DRAINS, UNLESS OTHERWISE NOTED.
- I. PROVIDE FIRESTOPPING, SLEEVES, AND SEALANTS AT FLOOR, WALL, AND CEILING PENETRATIONS; COORDINATE LOCATIONS WITH GC.

KEYED NOTES

- REMOVE AND REINSTALL WC TO ACCOMODATE NEW FLOORING INSTALLATION; COORDINATE WITH GC PRIOR TO COMMENCEMENT OF WORK.
- 2 DEMO (E) INSTA-HOT MODEL HOT-1
- DEMO PLUMBING FIXTURE AND ASSOCIATED WASTE/VENT PIPING BRANCHES. CAP PIPING AT A POINT BEYOND CONCEALMENT.
- DEMO WASTE BRANCH PIPING TO A POINT BEYOND CONCEALMENT AND CAP.

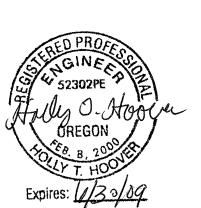

LRS »

V Davis

720 NW Davis Suite 300 Portland, OR 97209 Tel. 503.221.1121 Fax. 503.221.2077

503.221.2077 s

Munro &
Associates
consulting
engineers

18678 SW Boones Ferry Rd
Tualatin, Oregon 97062

Tualatin, Oregon 97062 tel 503.612.6500 fax 503.612.6588

CONSULTANTS

SENIOR CENTER
ON AND ADDITION
SW O'MARA ST.
S, OREGON 97223
& VENT PLAN

RENOVAT 881 TIGA WASTE


PROJECT NAME

ATE: 09.20.


CHECK: L

DRAWN BY:

PROJECT: 2070

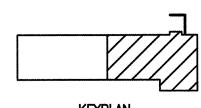

PL2.0Db

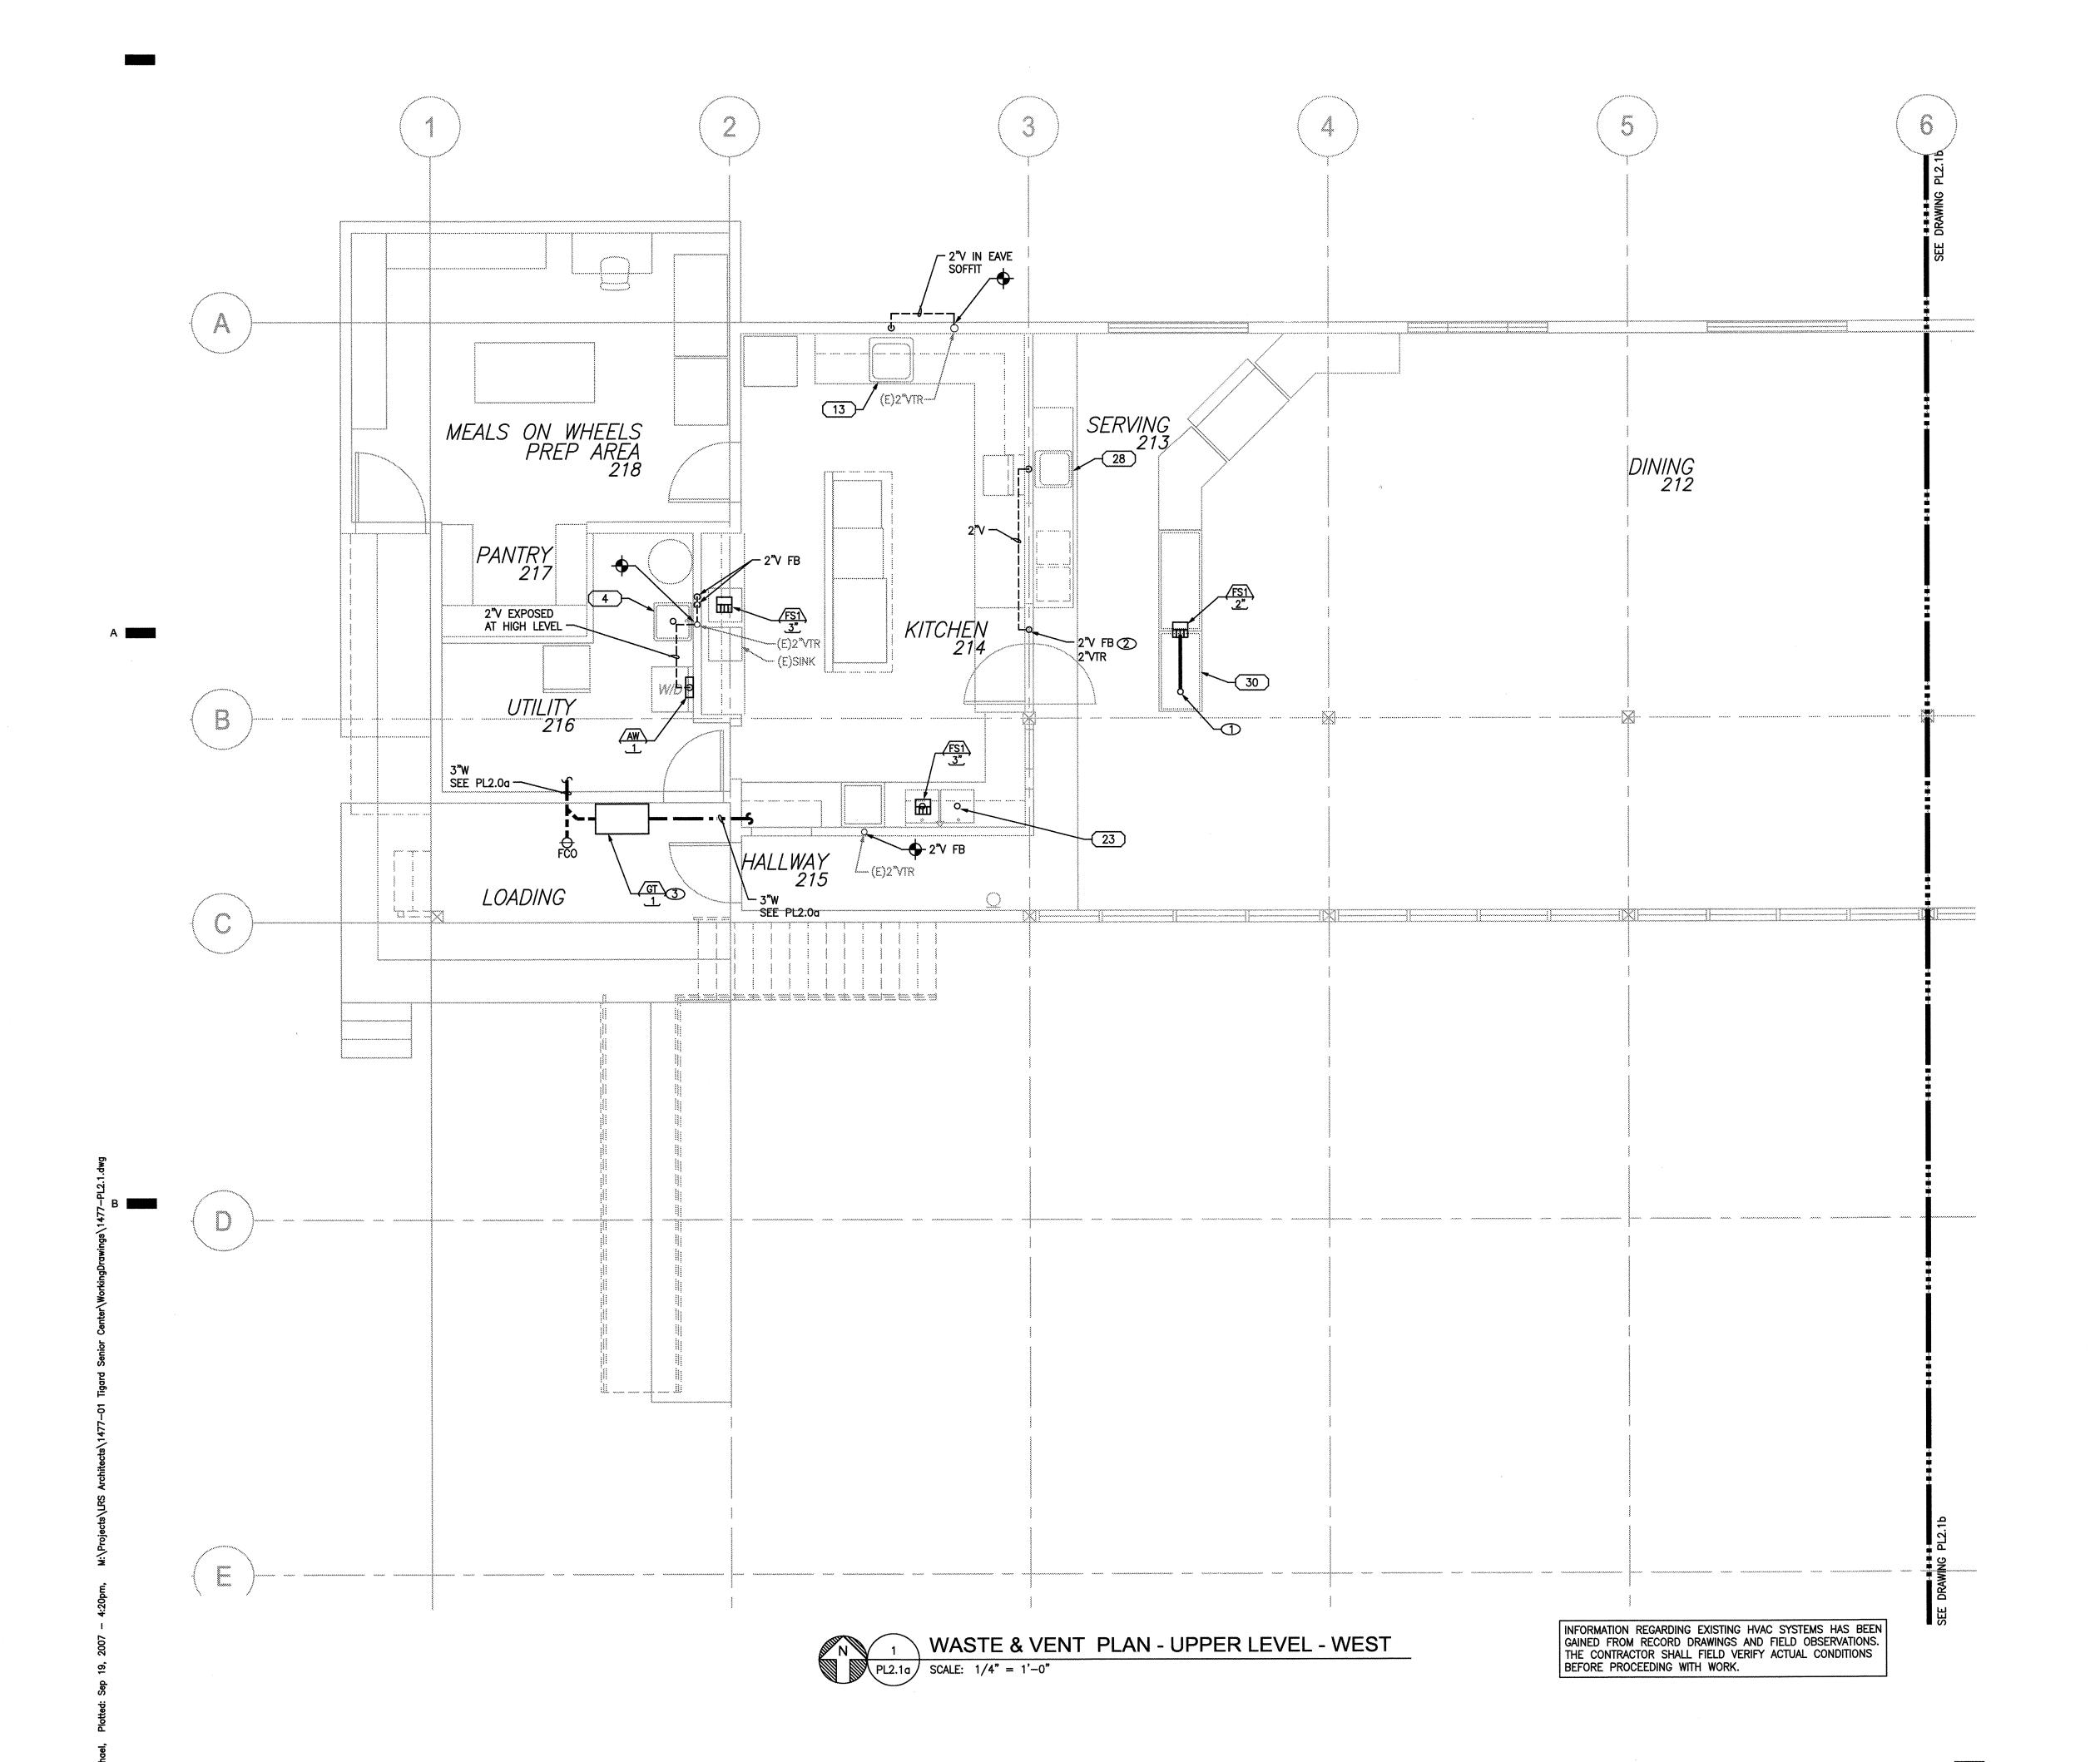


- A. SEE GENERAL PLUMBING NOTES ON DRAWING PLO.
- B. SEE PLUMBING FIXTURE SCHEDULE FOR BRANCH LINE AND CONNECTION SIZES.

OUTSIDE AIR INTAKES.

- C. SANITARY WASTE SLOPE, UNLESS OTHERWISE NOTED: PIPE SIZES 3" AND LARGER: 1/8" PER FOOT PIPE SIZES 2-1/2" AND SMALLER: 1/4" PER FOOT
- D. SLOPE STORM DRAIN LINES AT 1/8" PER FOOT UNLESS OTHERWISE NOTED.
- E. INVERT ELEVATIONS (I.E.) INDICATED ARE REFERENCED TO A FLOOR FINISHED HEIGHT OF 163.00 FEET. FIELD VERIFY.
- F. PLUMBING VENTS SHALL BE A MINIMUM OF 10 FEET AWAY FROM
- G. NOT ALL CLEANOUTS ARE SHOWN; CONTRACTOR IS RESPONSIBLE FOR PROVIDING CLEANOUTS IN ACCORDANCE WITH THE CODE; COORDINATE LOCATIONS OF CLEANOUTS WITH GC/OWNER REPRESENTATIVE.
- H. PROVIDE TRAP PRIMERS AT ALL FLOOR DRAINS, UNLESS OTHERWISE NOTED.
- I. PROVIDE FIRESTOPPING, SLEEVES, AND SEALANTS AT FLOOR, WALL, AND CEILING PENETRATIONS; COORDINATE LOCATIONS WITH

KEYED NOTES

- ① ID FROM WELL TO OVER FS
- ② FLASH AND COUNTERFLASH (N) ROOF PENETRATION
- 3 SET COVER FLUSH WITH DECK ELEVATION. ENCASE IN MIN. 4" THICK CONCRETE. TO SET ELEV. COORD. WITH STRUCTURAL

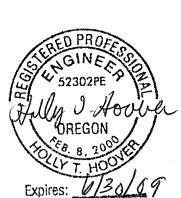

L R S a

o C Mavis

720 NW Davis Suite 300 Portland, OR 97209 Tel. 503.221.1121 Fax. 503.221.2077

Munro & Associates consulting engineers

18678 SW Boones Ferry Rd Tualatin, Oregon 97062

tel 503.612.6500 fax 503.612.6588

CONSULTANTS


GARD SENIOR CENTER OVATION AND ADDITION 8815 SW O'MARA ST. TIGARD, OREGON 97223

PROJECT	NAN

ATE: 09.17.

CHECK: L


PROJECT: 207037

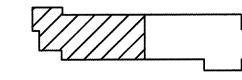

KEYP

PL2.1a




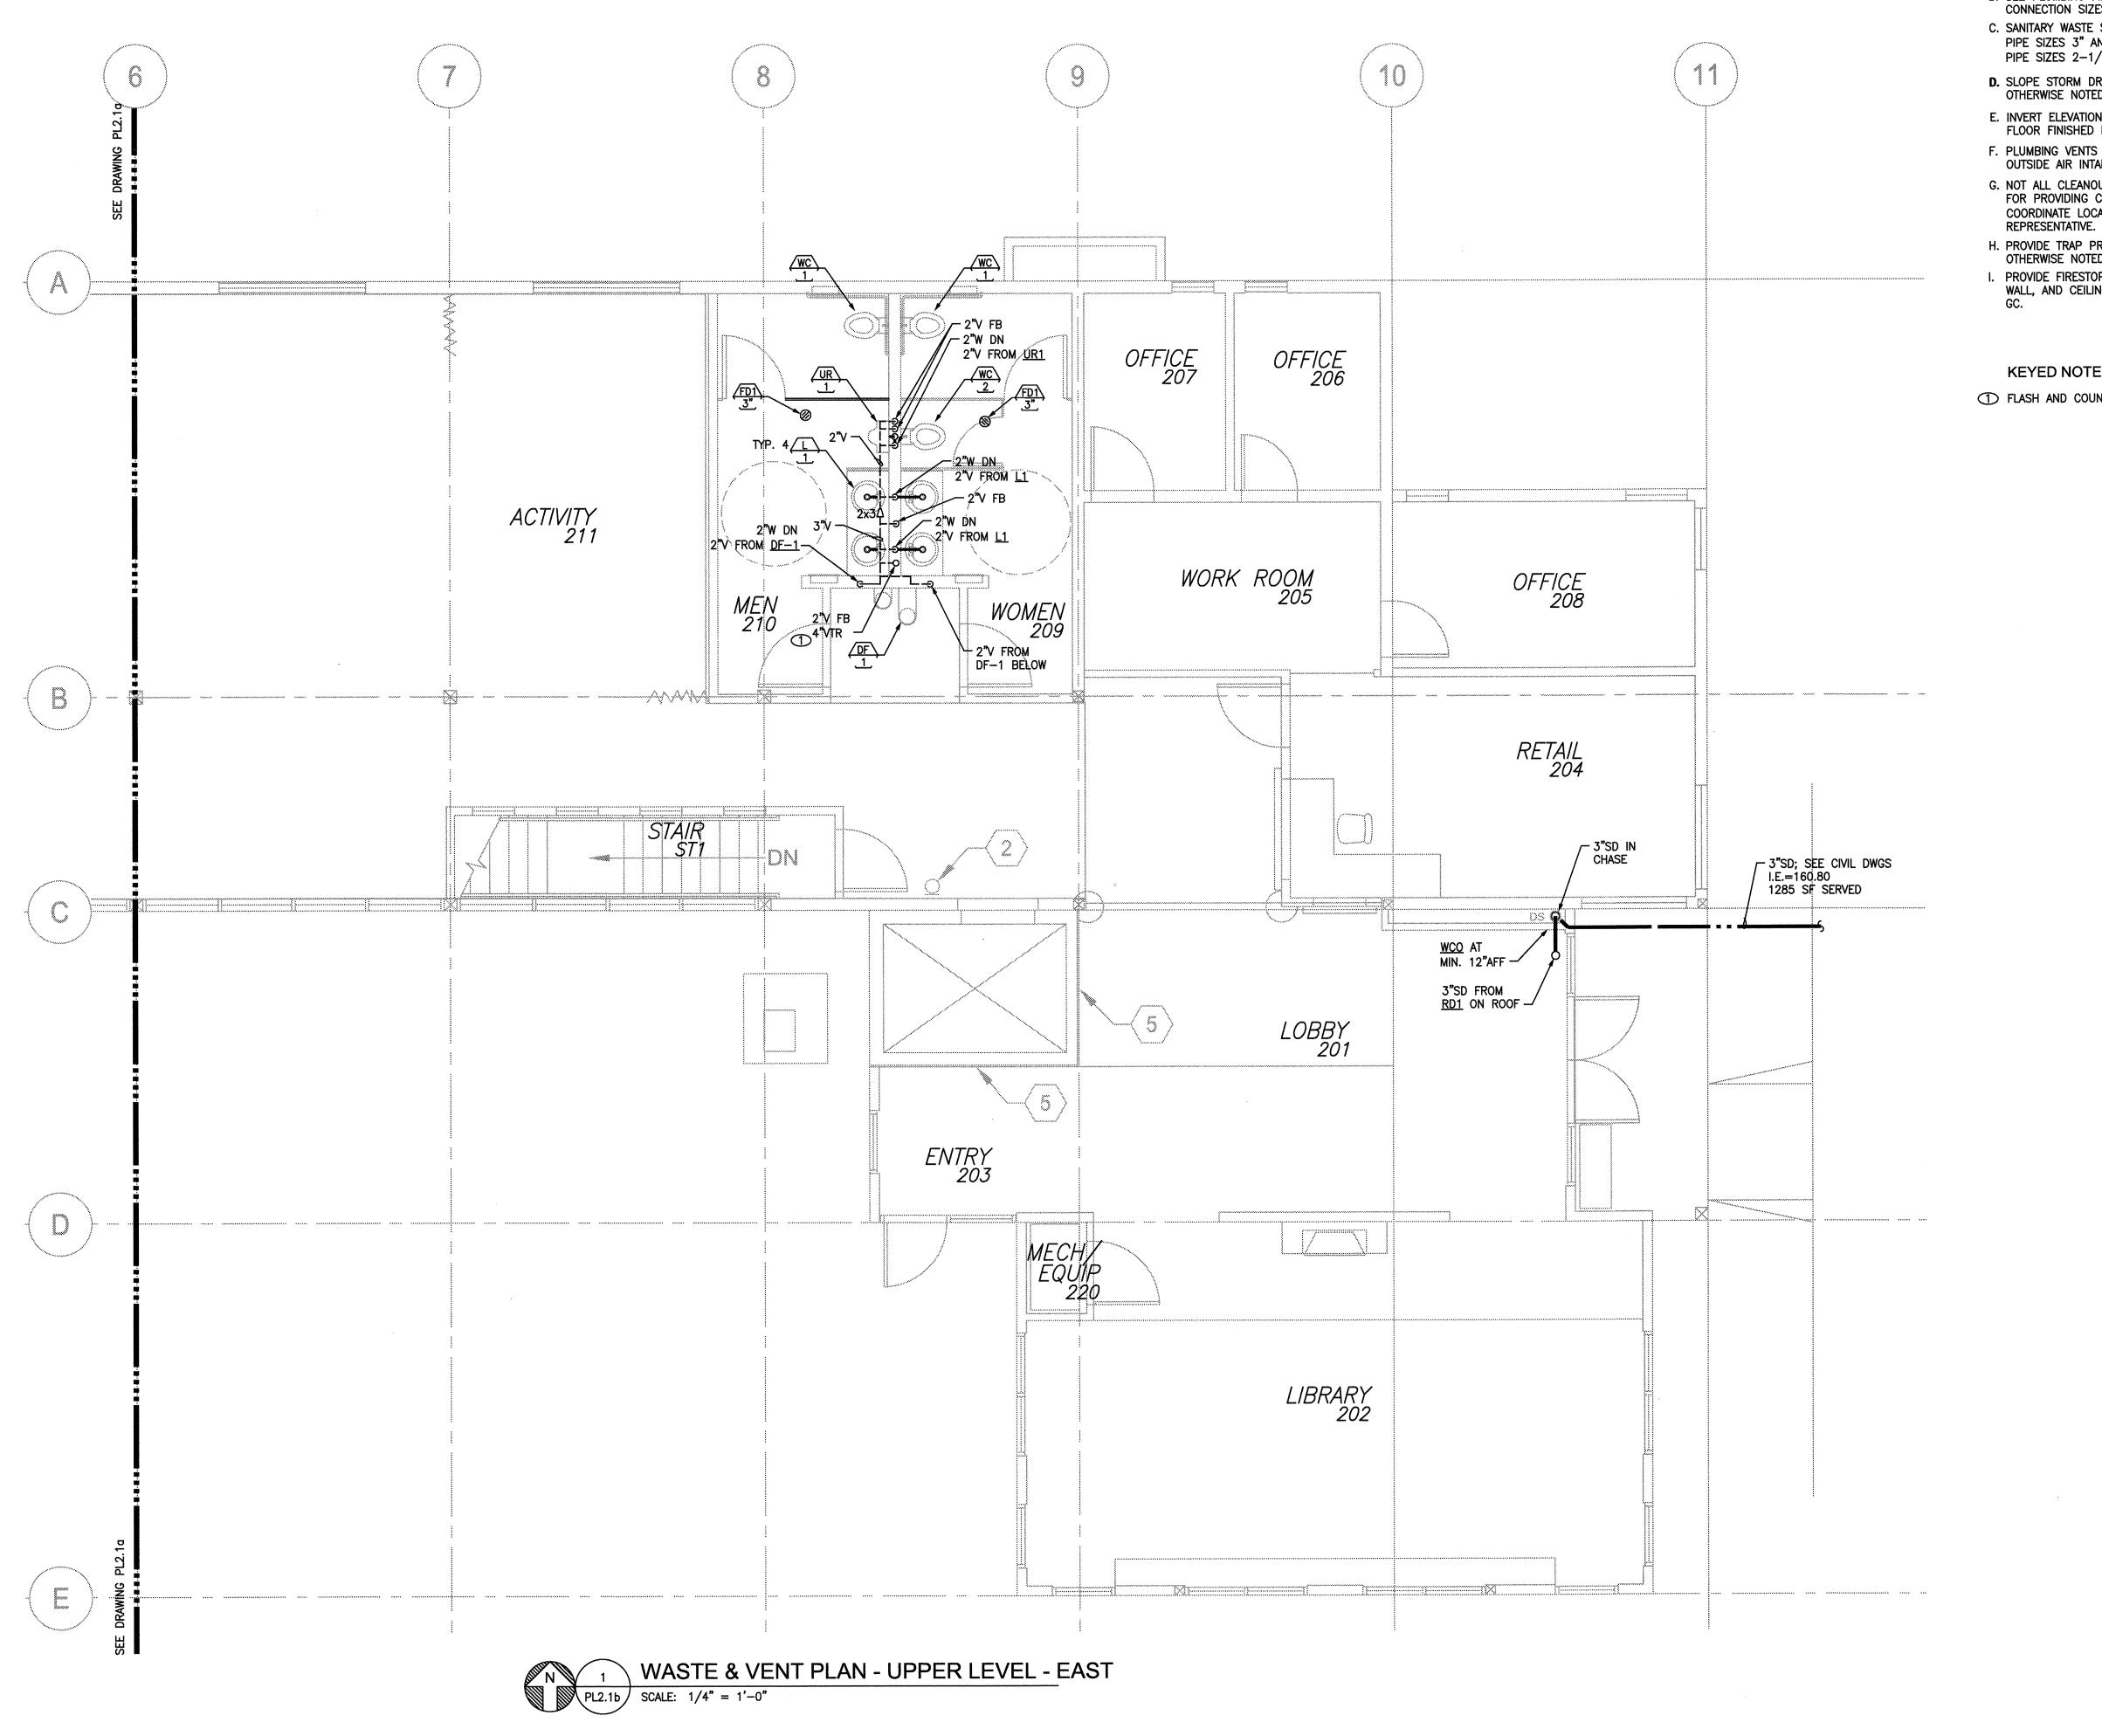

- A. SEE GENERAL PLUMBING NOTES ON DRAWING PLO.
- B. SEE PLUMBING FIXTURE SCHEDULE FOR BRANCH LINE AND CONNECTION SIZES.
- C. SANITARY WASTE SLOPE, UNLESS OTHERWISE NOTED: PIPE SIZES 3" AND LARGER: 1/8" PER FOOT PIPE SIZES 2-1/2" AND SMALLER: 1/4" PER FOOT
- D. SLOPE STORM DRAIN LINES AT 1/8" PER FOOT UNLESS OTHERWISE NOTED.
- E. INVERT ELEVATIONS (I.E.) INDICATED ARE REFERENCED TO A FLOOR FINISHED HEIGHT OF 163.00 FEET. FIELD VERIFY.
- F. PLUMBING VENTS SHALL BE A MINIMUM OF 10 FEET AWAY FROM OUTSIDE AIR INTAKES.
- G. NOT ALL CLEANOUTS ARE SHOWN; CONTRACTOR IS RESPONSIBLE FOR PROVIDING CLEANOUTS IN ACCORDANCE WITH THE CODE; COORDINATE LOCATIONS OF CLEANOUTS WITH GC/OWNER
- H. PROVIDE TRAP PRIMERS AT ALL FLOOR DRAINS, UNLESS OTHERWISE NOTED.
- I. PROVIDE FIRESTOPPING, SLEEVES, AND SEALANTS AT FLOOR, WALL, AND CEILING PENETRATIONS; COORDINATE LOCATIONS WITH

KEYED NOTES

1 FLASH AND COUNTERFLASH NEW PENETRATION OF ROOF.

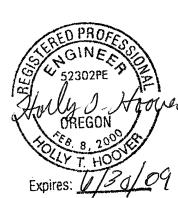

720 NW Davis Suite 300 Portland, OR 97209 Tel. 503.221.1121

Fax. 503.221.2077

mya

Munro &


Associates consulting engineers 18678 SW Boones Ferry Rd Tualatin, Oregon 97062

tel 503.612.6500 fax 503.612.6588


CONSULTANTS


10N

PROJECT NAME

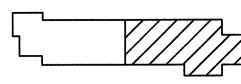

PL2.1b

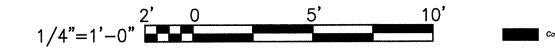

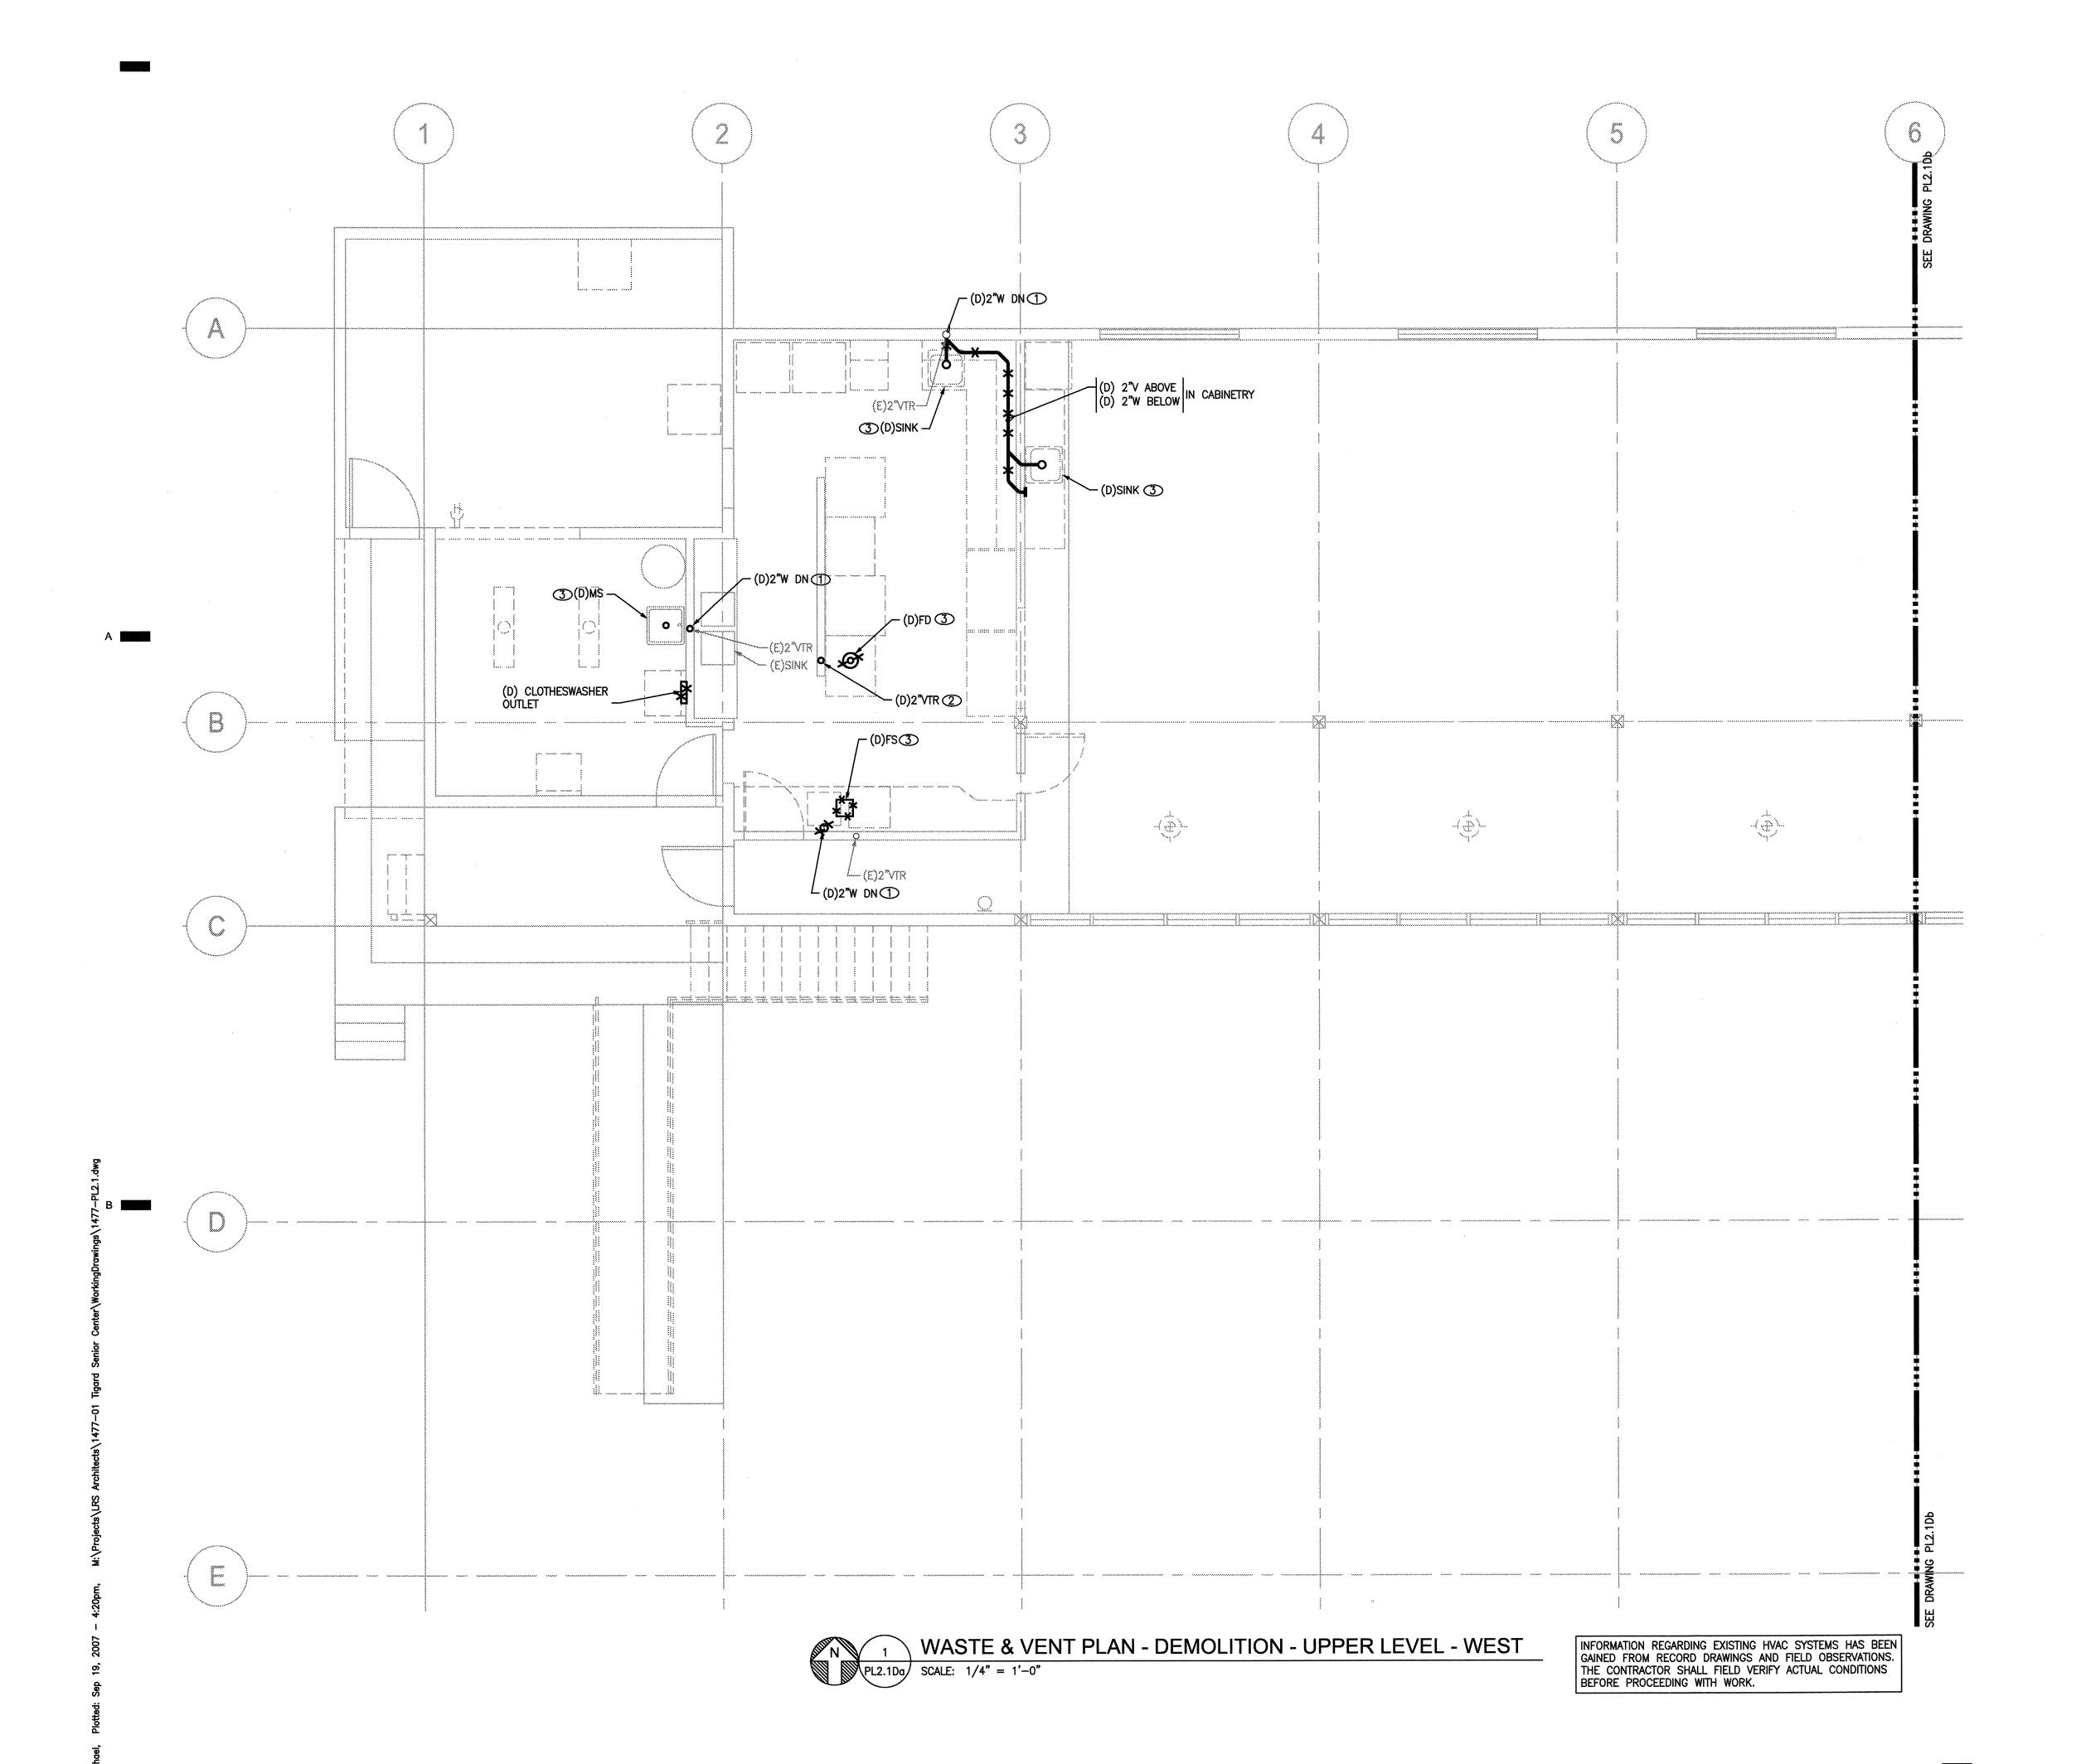

- A. SEE GENERAL PLUMBING NOTES ON DRAWING PLO.
- B. SEE PLUMBING FIXTURE SCHEDULE FOR BRANCH LINE AND CONNECTION SIZES.
- C. SANITARY WASTE SLOPE, UNLESS OTHERWISE NOTED: PIPE SIZES 3" AND LARGER: 1/8" PER FOOT PIPE SIZES 2-1/2" AND SMALLER: 1/4" PER FOOT
- D. SLOPE STORM DRAIN LINES AT 1/8" PER FOOT UNLESS OTHERWISE NOTED.
- E. INVERT ELEVATIONS (I.E.) INDICATED ARE REFERENCED TO A FLOOR FINISHED HEIGHT OF 163.00 FEET. FIELD VERIFY.
- F. PLUMBING VENTS SHALL BE A MINIMUM OF 10 FEET AWAY FROM OUTSIDE AIR INTAKES.
- G. NOT ALL CLEANOUTS ARE SHOWN; CONTRACTOR IS RESPONSIBLE FOR PROVIDING CLEANOUTS IN ACCORDANCE WITH THE CODE; COORDINATE LOCATIONS OF CLEANOUTS WITH GC/OWNER REPRESENTATIVE.
- H. PROVIDE TRAP PRIMERS AT ALL FLOOR DRAINS, UNLESS OTHERWISE NOTED.
- I. PROVIDE FIRESTOPPING, SLEEVES, AND SEALANTS AT FLOOR, WALL, AND CEILING PENETRATIONS; COORDINATE LOCATIONS WITH GC.

KEYED NOTES

- ① DEMO WASTE FOR (N) VENT CONNECTION.
- ② DEMO VTR AND PATCH ROOF WEATHERTIGHT.
- 3 DEMO PLUMBING FIXTURE AND ASSOCIATED WASTE/VENT PIPING BRANCHES.



LRS a

720 NW Davis
Suite 300
Portland, OR 97209
Tel. 503.221.1121
Fax. 503.221.2077

Munro & Associates

consulting engineers 18678 SW Boones Ferry Rd Tualatin, Oregon 97062

tel 503.612.6500

fax 503.612.6588

CONSULTANTS

OR CENTER ND ADDITION MARA ST. GON 97223 ENT PLAN


IGARD SENIOR NOVATION AND 8815 SW O'MARA TIGARD, OREGON

E: 09.17.07

CHECK:

DRAWN BY: R


PROJECT: 20703

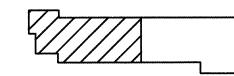

KEYPL

PL2.1Da



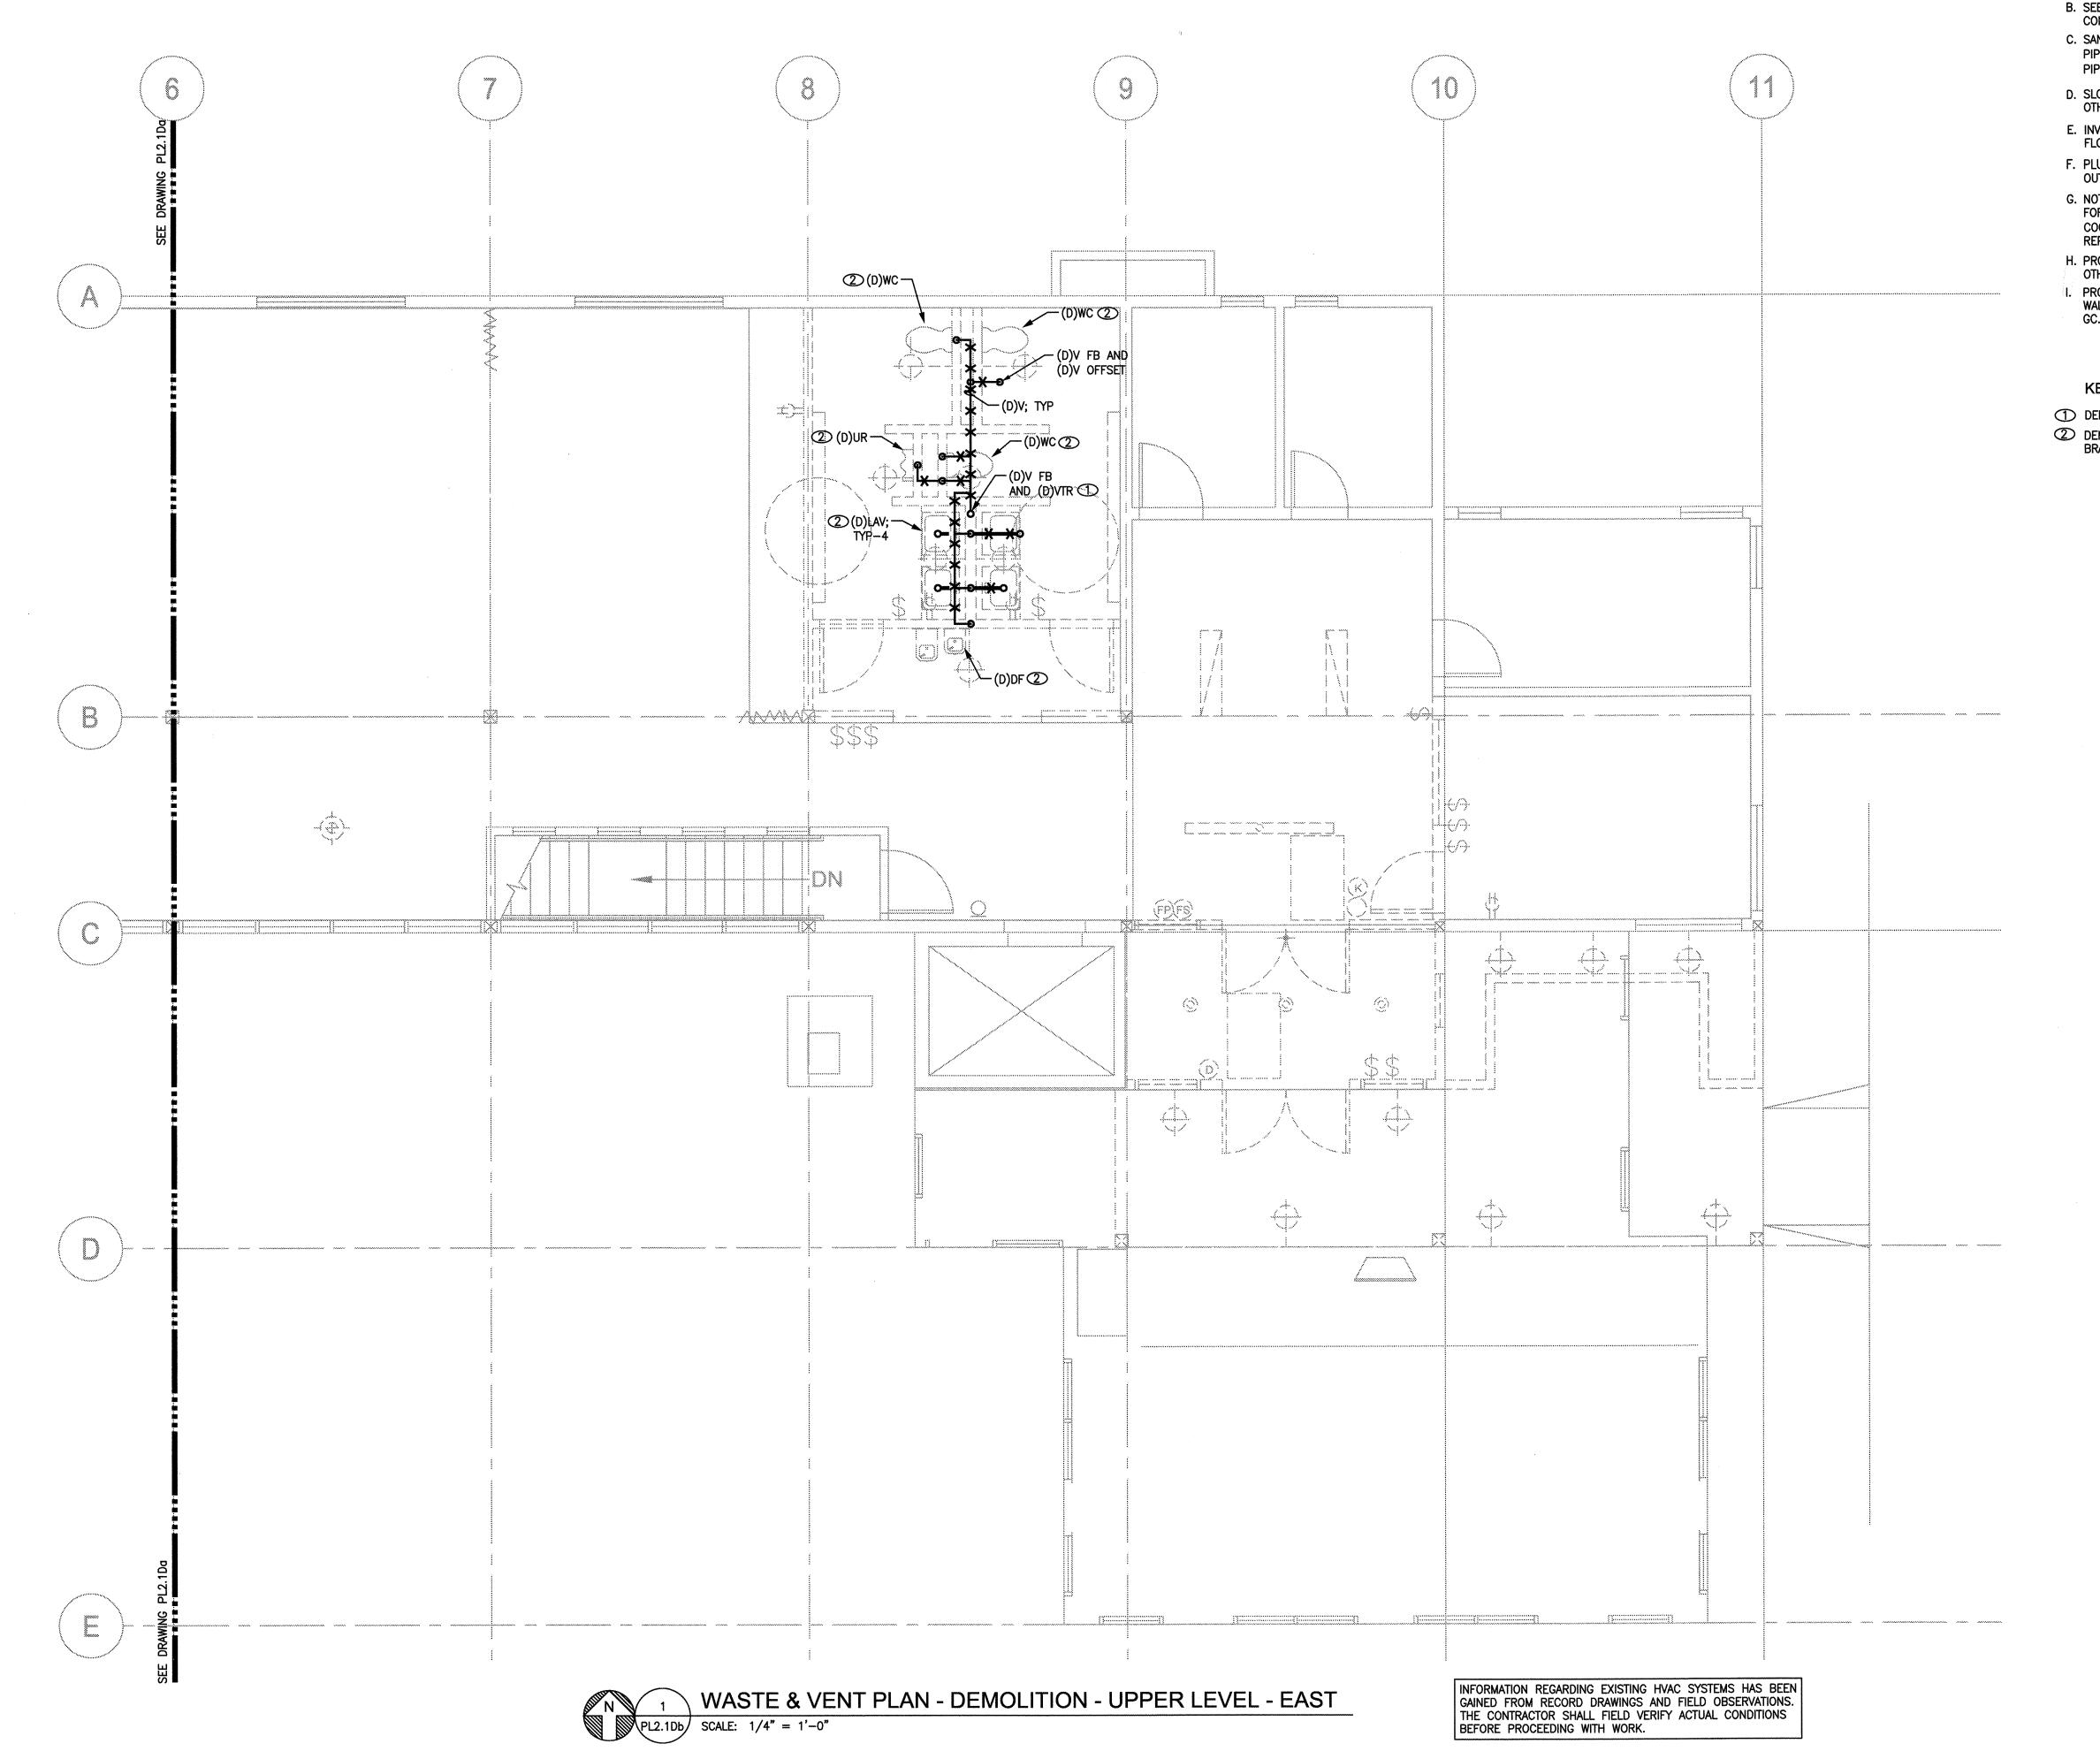

- A. SEE GENERAL PLUMBING NOTES ON DRAWING PLO.
- B. SEE PLUMBING FIXTURE SCHEDULE FOR BRANCH LINE AND CONNECTION SIZES.
- C. SANITARY WASTE SLOPE, UNLESS OTHERWISE NOTED: PIPE SIZES 3" AND LARGER: 1/8" PER FOOT
- PIPE SIZES 2-1/2" AND SMALLER: 1/4" PER FOOT
- D. SLOPE STORM DRAIN LINES AT 1/8" PER FOOT UNLESS OTHERWISE NOTED.
- E. INVERT ELEVATIONS (I.E.) INDICATED ARE REFERENCED TO A FLOOR FINISHED HEIGHT OF 163.00 FEET. FIELD VERIFY.
- F. PLUMBING VENTS SHALL BE A MINIMUM OF 10 FEET AWAY FROM OUTSIDE AIR INTAKES.
- G. NOT ALL CLEANOUTS ARE SHOWN; CONTRACTOR IS RESPONSIBLE FOR PROVIDING CLEANOUTS IN ACCORDANCE WITH THE CODE; COORDINATE LOCATIONS OF CLEANOUTS WITH GC/OWNER REPRESENTATIVE.
- H. PROVIDE TRAP PRIMERS AT ALL FLOOR DRAINS, UNLESS OTHERWISE NOTED.
- I. PROVIDE FIRESTOPPING, SLEEVES, AND SEALANTS AT FLOOR, WALL, AND CEILING PENETRATIONS; COORDINATE LOCATIONS WITH GC

KEYED NOTES

- ① DEMO VTR AND PATCH ROOF WEATHERTIGHT.
- ② DEMO PLUMBING FIXTURE AND ASSOCIATED WASTE/VENT PIPING BRANCHES.



R S

720 NW Davis
Suite 300
Portland, OR 97200

Portland, OR 97209 Tel. 503.221.1121 Fax. 503.221.2077

Munro & Associates consulting engineers

18678 SW Boones Ferry Rd Tualatin, Oregon 97062

tel 503.612.6500

fax 503.612.6588

CONSULTANTS

OONOGENANT

D SENIOR CENTER
TION AND ADDITION
15 SW O'MARA ST.
ARD, OREGON 97223
E & VENT PLAN

RENO

PROJECT NAME


E: 09.17.07


DRAWN BY: RM7

PROJECT: 20703

KFYPI

PL2.1Db

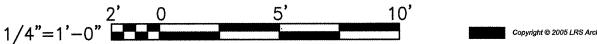

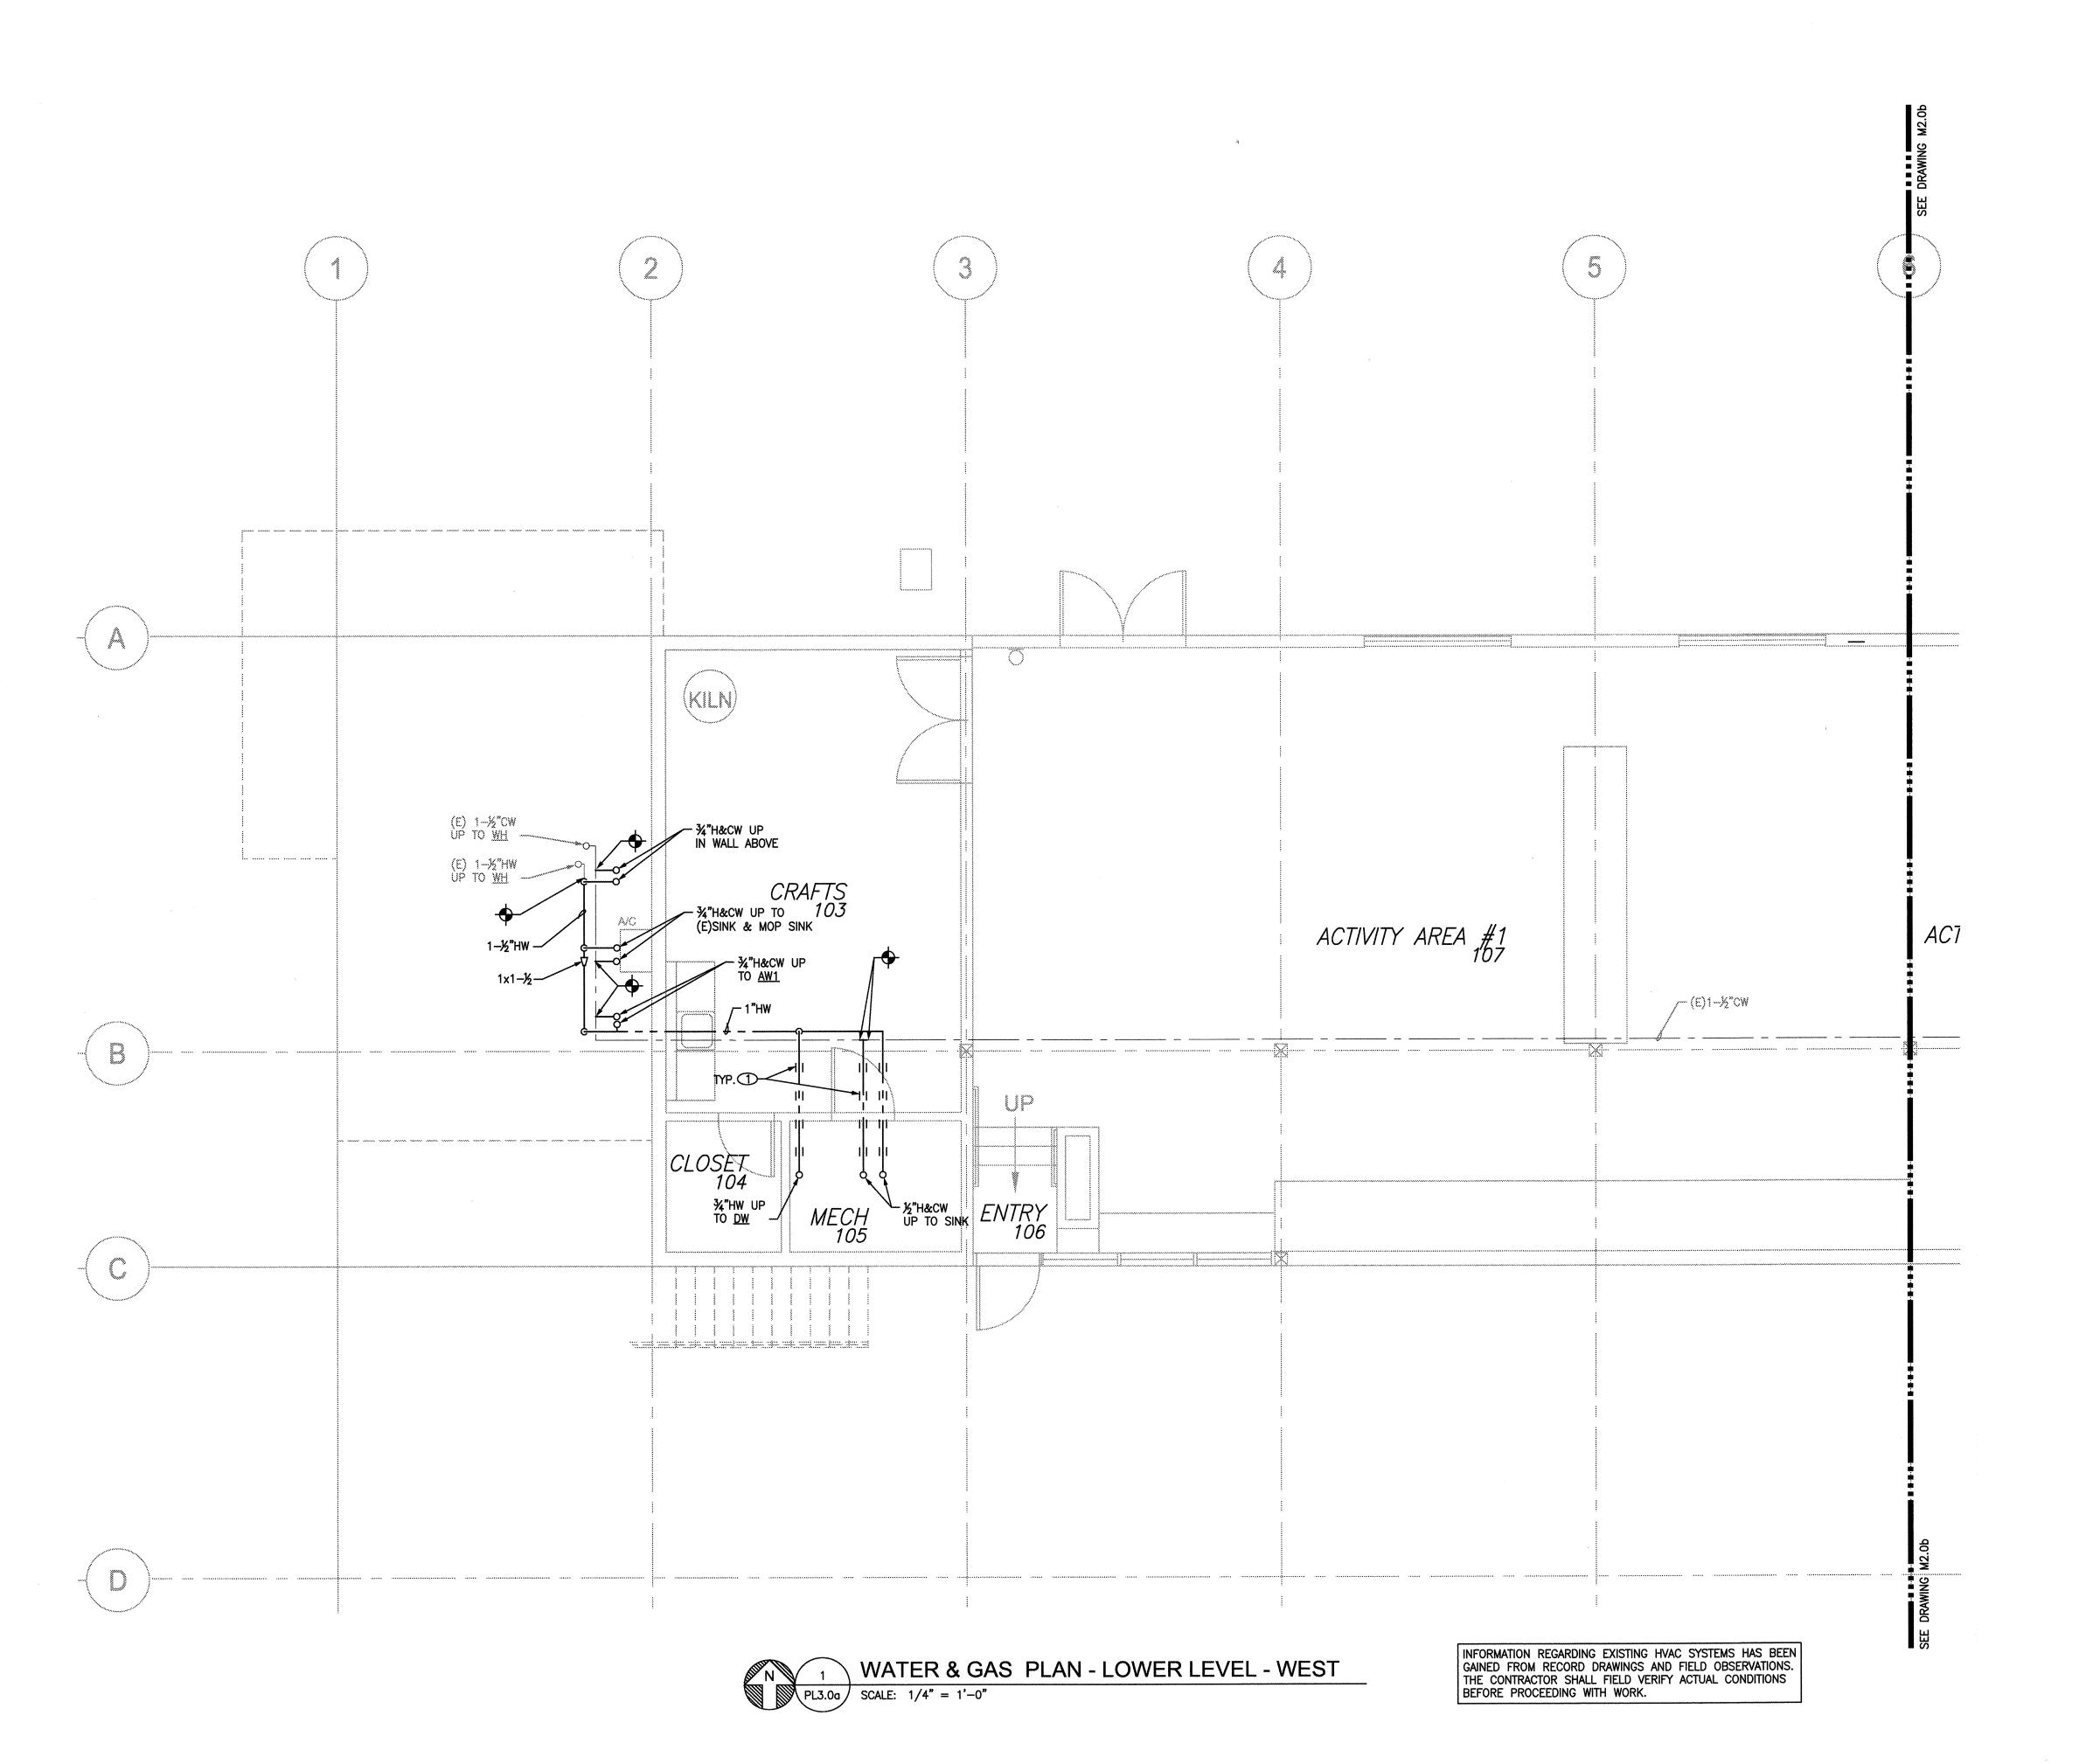



- A. SEE GENERAL PLUMBING NOTES ON DRAWING PLO.

 B. SEE PLUMBING FIXTURE SCHEDULE FOR BRANCH LINE AND
- CONNECTION SIZES.

 C. DOMESTIC WATER SYSTEM IS BASED ON THE FOLLOWING INFORMATION AVAILABLE AT THE TIME OF SYSTEM DESIGN:

 MINIMUM AVAILABLE WATER PRESSURE: 70 PSIG
- MAXIMUM AVAILABLE WATER PRESSURE: 104 PSIG

 D. PROVIDE STOPS AND SUPPLIES FOR HW AND CW CONNECTIONS
 TO PLUMBING FIXTURES AND EQUIPMENT.
- E. PROVIDE TRAP PRIMERS AT ALL FLOOR DRAINS, UNLESS OTHERWISE NOTED.
- F. PROVIDE FIRESTOPPING, SLEEVES, AND SEALANTS AT FLOOR, WALL, AND CEILING PENETRATIONS; COORDINATE LOCATIONS WITH GC.

KEYED NOTES

PENETRATE THRU (E) FLOOR JOISTS. TYPICAL SEE STRUCTURAL DWGS.



R S

c h l t e c t

720 NW Davis Suite 300 Portland, OR 97209 Tel. 503.221.1121 Fax. 503.221.2077

Munro & Associates consulting engineers

18678 SW Boones Ferry Rd Tualatin, Oregon 97062

tel 503.612.6500

fax 503.612.6588

CONSULTANTS

RD SENIOR CENTER
'ATION AND ADDITION
8815 SW O'WARA ST.
IGARD, OREGON 97223


PROJECT NAME

ATE: 09.20.

CHECK: L


DRAWN BY: RM

PROJECT: 20703

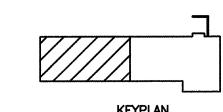

PL3.0a

2' 0 5' 10' 4"=1'-0" Copyright © 2005 LRS Archi

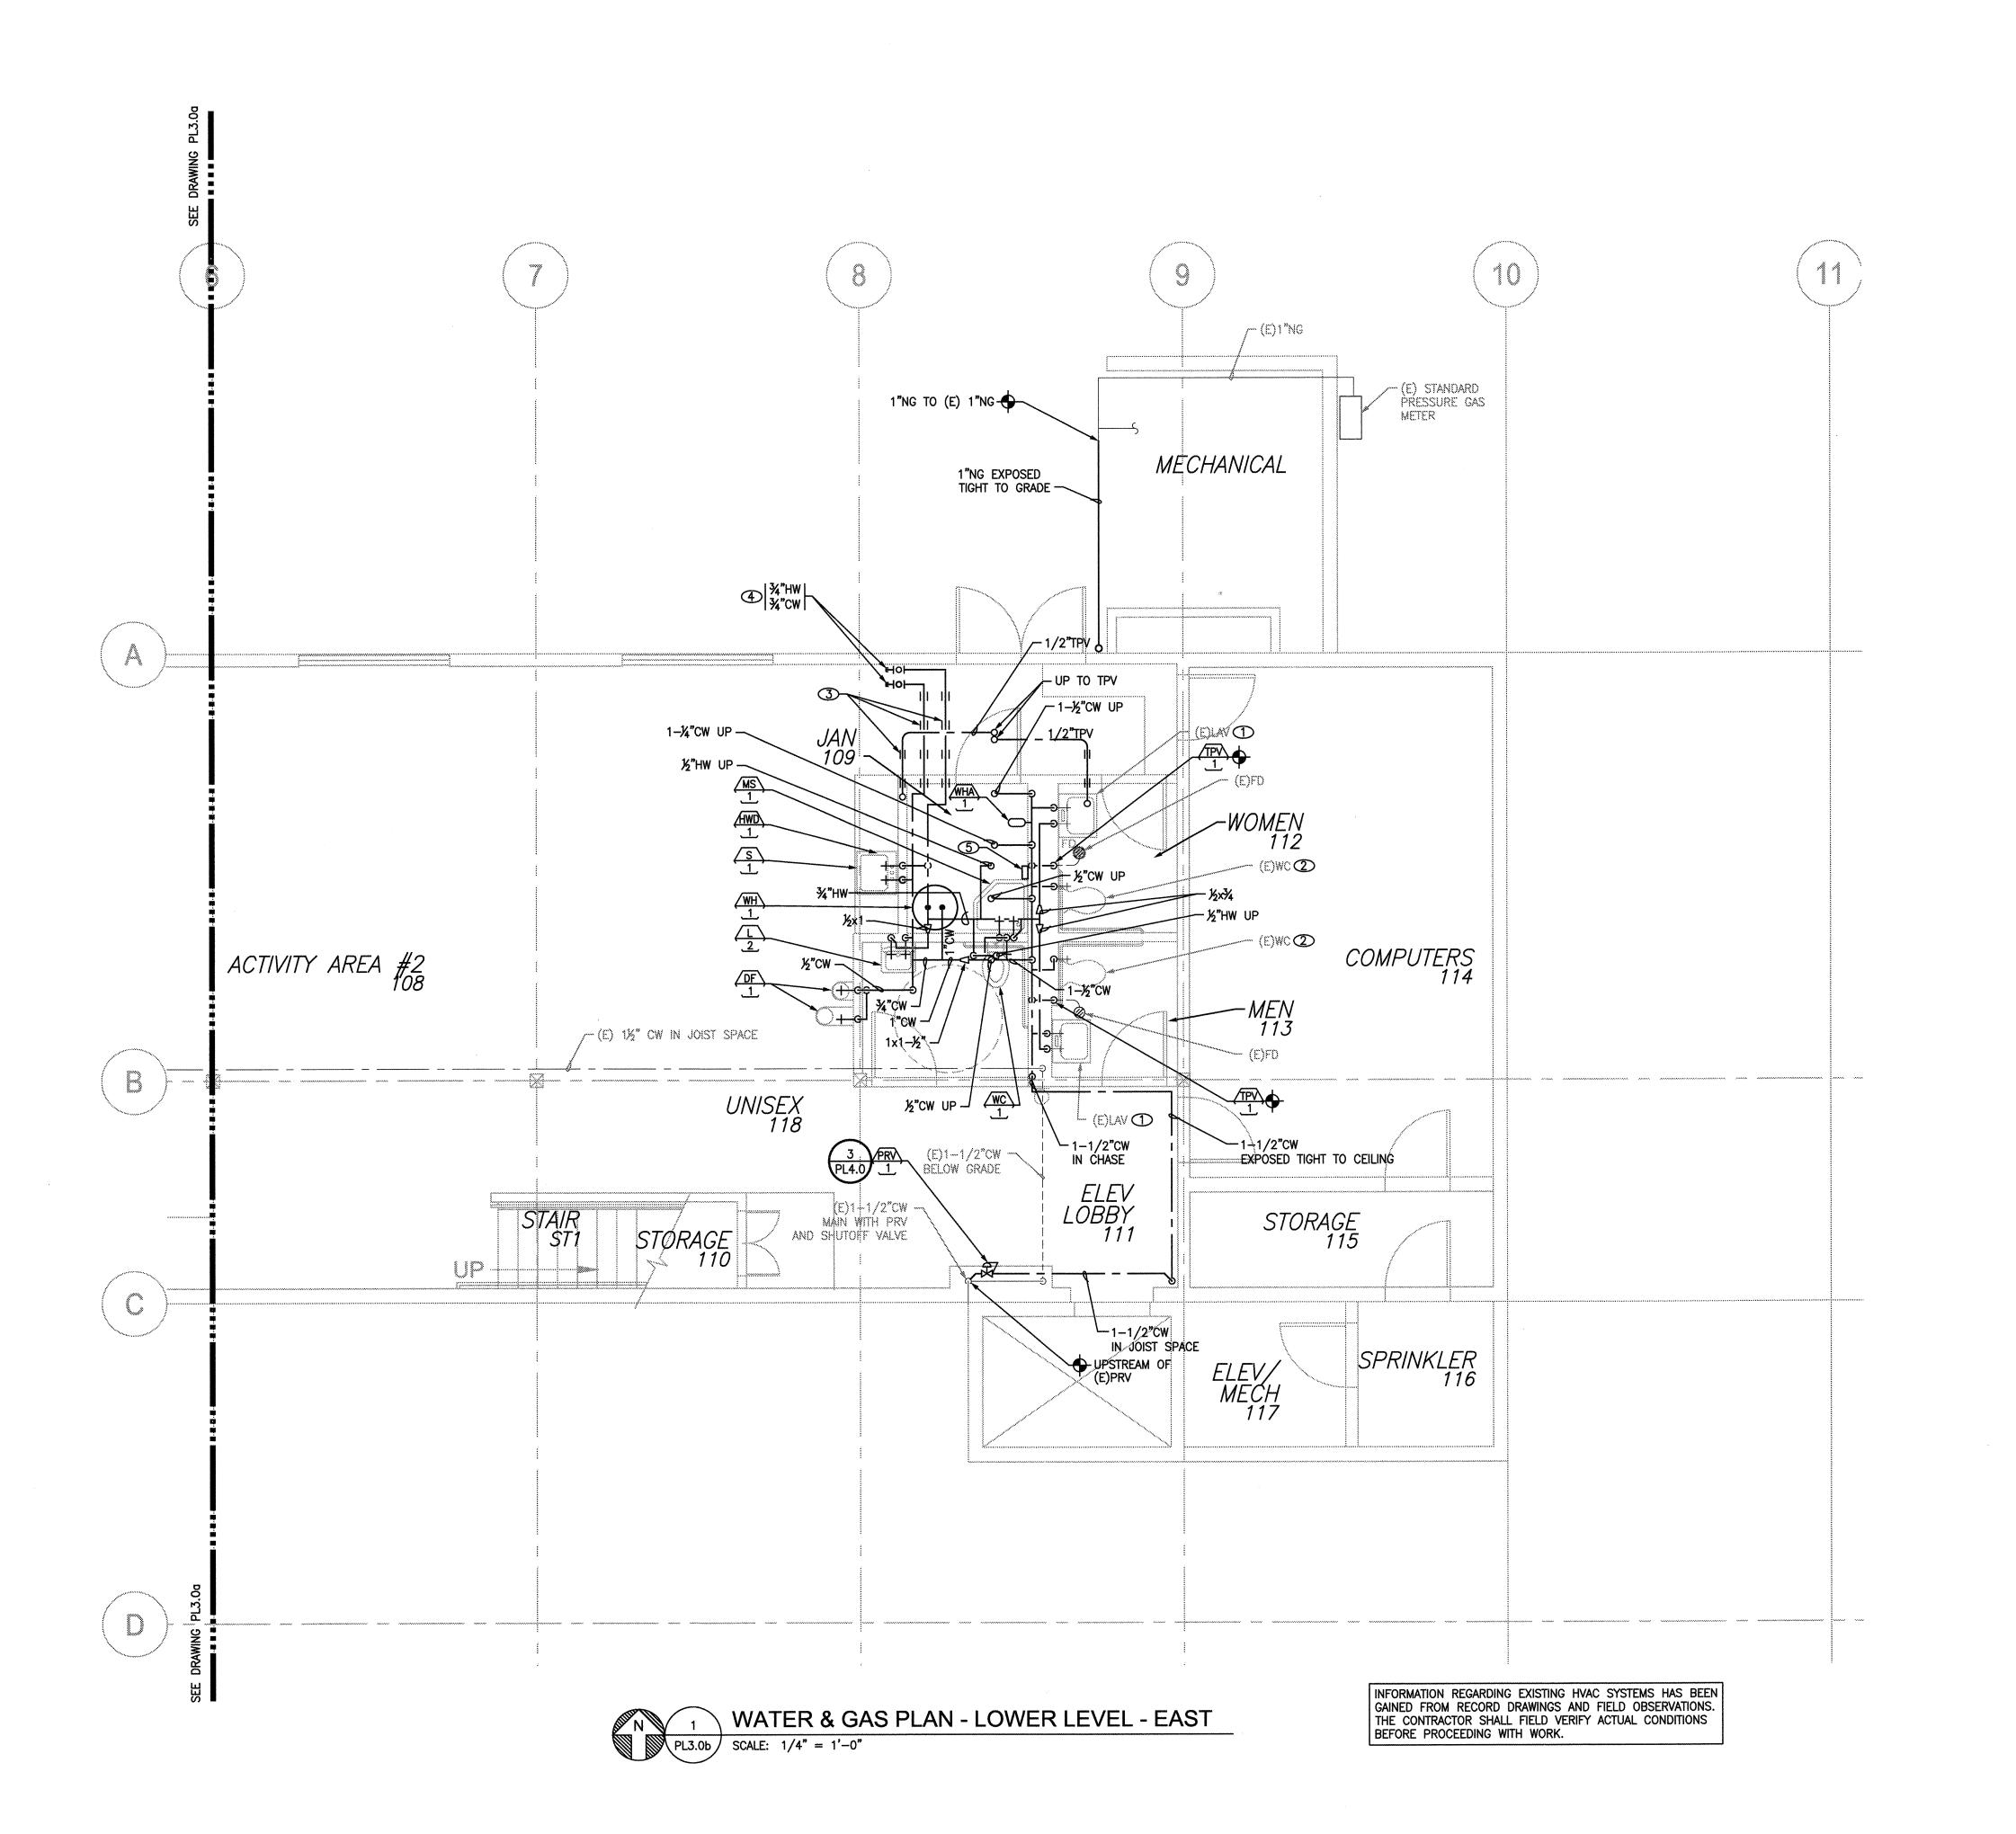


- A. SEE GENERAL PLUMBING NOTES ON DRAWING PLO.
- B. SEE PLUMBING FIXTURE SCHEDULE FOR BRANCH LINE AND CONNECTION SIZES.
- C. DOMESTIC WATER SYSTEM IS BASED ON THE FOLLOWING INFORMATION AVAILABLE AT THE TIME OF SYSTEM DESIGN:
 MINIMUM AVAILABLE WATER PRESSURE: 70 PSIG
- MAXIMUM AVAILABLE WATER PRESSURE: 104 PSIG

 D. PROVIDE STOPS AND SUPPLIES FOR HW AND CW CONNECTIONS
 TO PLUMBING FIXTURES AND EQUIPMENT.
- E. PROVIDE TRAP PRIMERS AT ALL FLOOR DRAINS, UNLESS
- OTHERWISE NOTED.
- F. PROVIDE FIRESTOPPING, SLEEVES, AND SEALANTS AT FLOOR, WALL, AND CEILING PENETRATIONS; COORDINATE LOCATIONS WITH CC

KEYED NOTES

- ① CONNECT (N) HW/CW STOPS TO (E) HW/CW SUPPLIES.
- ② CONNECT (N) CW BRANCH TO (E) FLUSH VALVE.
- ③ SLEEVE THRU JOIST. SEE STRUCTURAL DWGS. TYP.
- (4) CAP AND VALVE IN JOIST SPACE FOR FUTURE GARDEN ROOM. 2.0 GPM
- 5 TRANSFORMER FOR INFRARED FLUSH VALVES. COORDINATE LOW-VOLTAGE WIRING TO VALVES WITH ELECTRICAL.

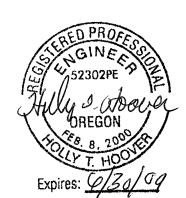

R S

720 NW Davis Suite 300 Portland, OR 97209 Tel. 503.221.1121

Fax. 503.221.2077

Munro & Associates consulting engineers 18678 SW Boones Ferry Rd Tualatin, Oregon 97062

Tualatin, Oregon 97062
tel 503.612.6500
fax 503.612.6588

CONSULTANTS

RD SENIOR CENTER YATION AND ADDITION 8815 SW O'MARA ST. IGARD, OREGON 97223 TER & GAS PLAN


PROJECT NAME

·: 09.20.0


CHECK:


DRAWN BY: R

PROJECT: 20703

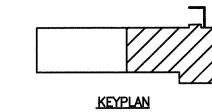

PL3.0b

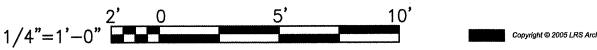

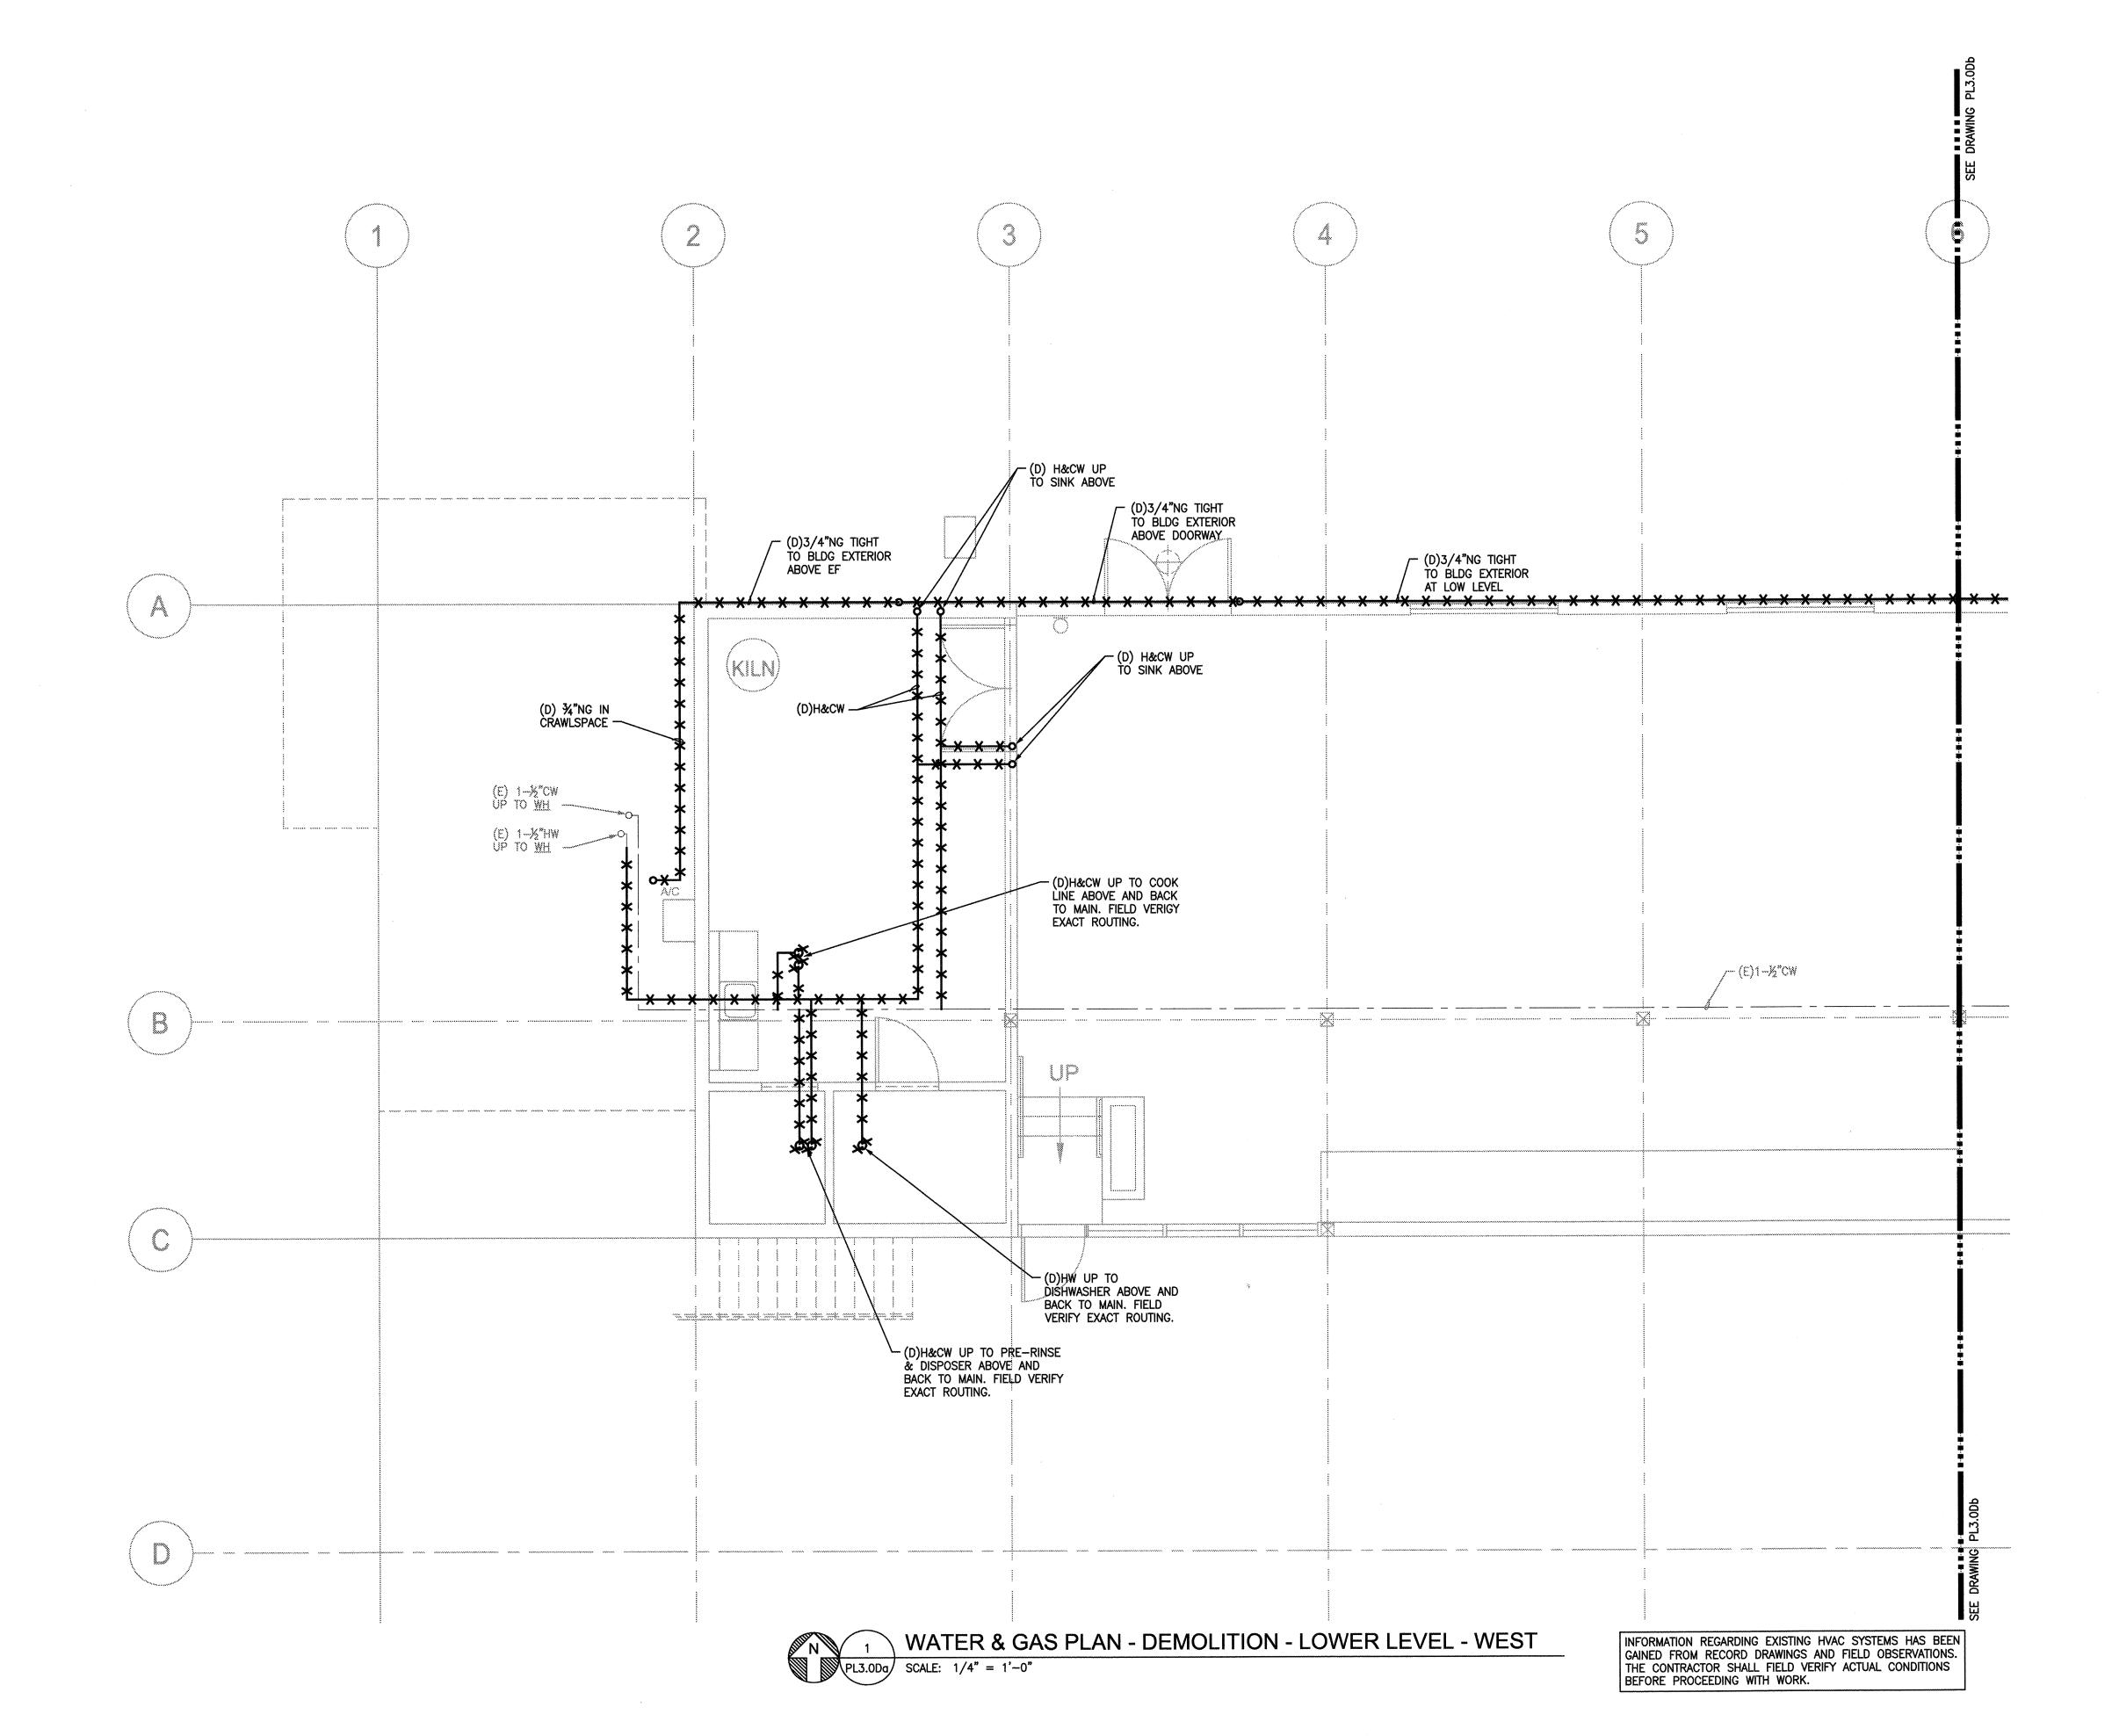

- A. SEE GENERAL PLUMBING NOTES ON DRAWING PLO.

 B. SEE PLUMBING FIXTURE SCHEDULE FOR BRANCH LINE
- B. SEE PLUMBING FIXTURE SCHEDULE FOR BRANCH LINE AND CONNECTION SIZES.
- C. DOMESTIC WATER SYSTEM IS BASED ON THE FOLLOWING INFORMATION AVAILABLE AT THE TIME OF SYSTEM DESIGN:

 MINIMUM AVAILABLE WATER PRESSURE: 70 PSIG MAXIMUM AVAILABLE WATER PRESSURE: 104 PSIG
- D. PROVIDE STOPS AND SUPPLIES FOR HW AND CW CONNECTIONS
 TO PLUMBING FIXTURES AND EQUIPMENT.
- E. PROVIDE TRAP PRIMERS AT ALL FLOOR DRAINS, UNLESS OTHERWISE NOTED.
- F. PROVIDE FIRESTOPPING, SLEEVES, AND SEALANTS AT FLOOR, WALL, AND CEILING PENETRATIONS; COORDINATE LOCATIONS WITH

maa

720 NW Davis Suite 300

Portland, OR 97209 Tel. 503.221.1121 Fax. 503.221.2077

Munro &
Associates
consulting
engineers
SW Boones Ferry Rd

18678 SW Boones Ferry Rd Tualatin, Oregon 97062 tel 503.612.6500 fax 503.612.6588

CONSULTANTS

SWO'MARA ST.
D, OREGON 97223
R & GAS PLAN


RENOV.

PROJECT NAME


TE: 09.20.07

CHECK: LE

PROJECT: 207037

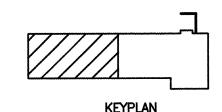

PL3.0Da

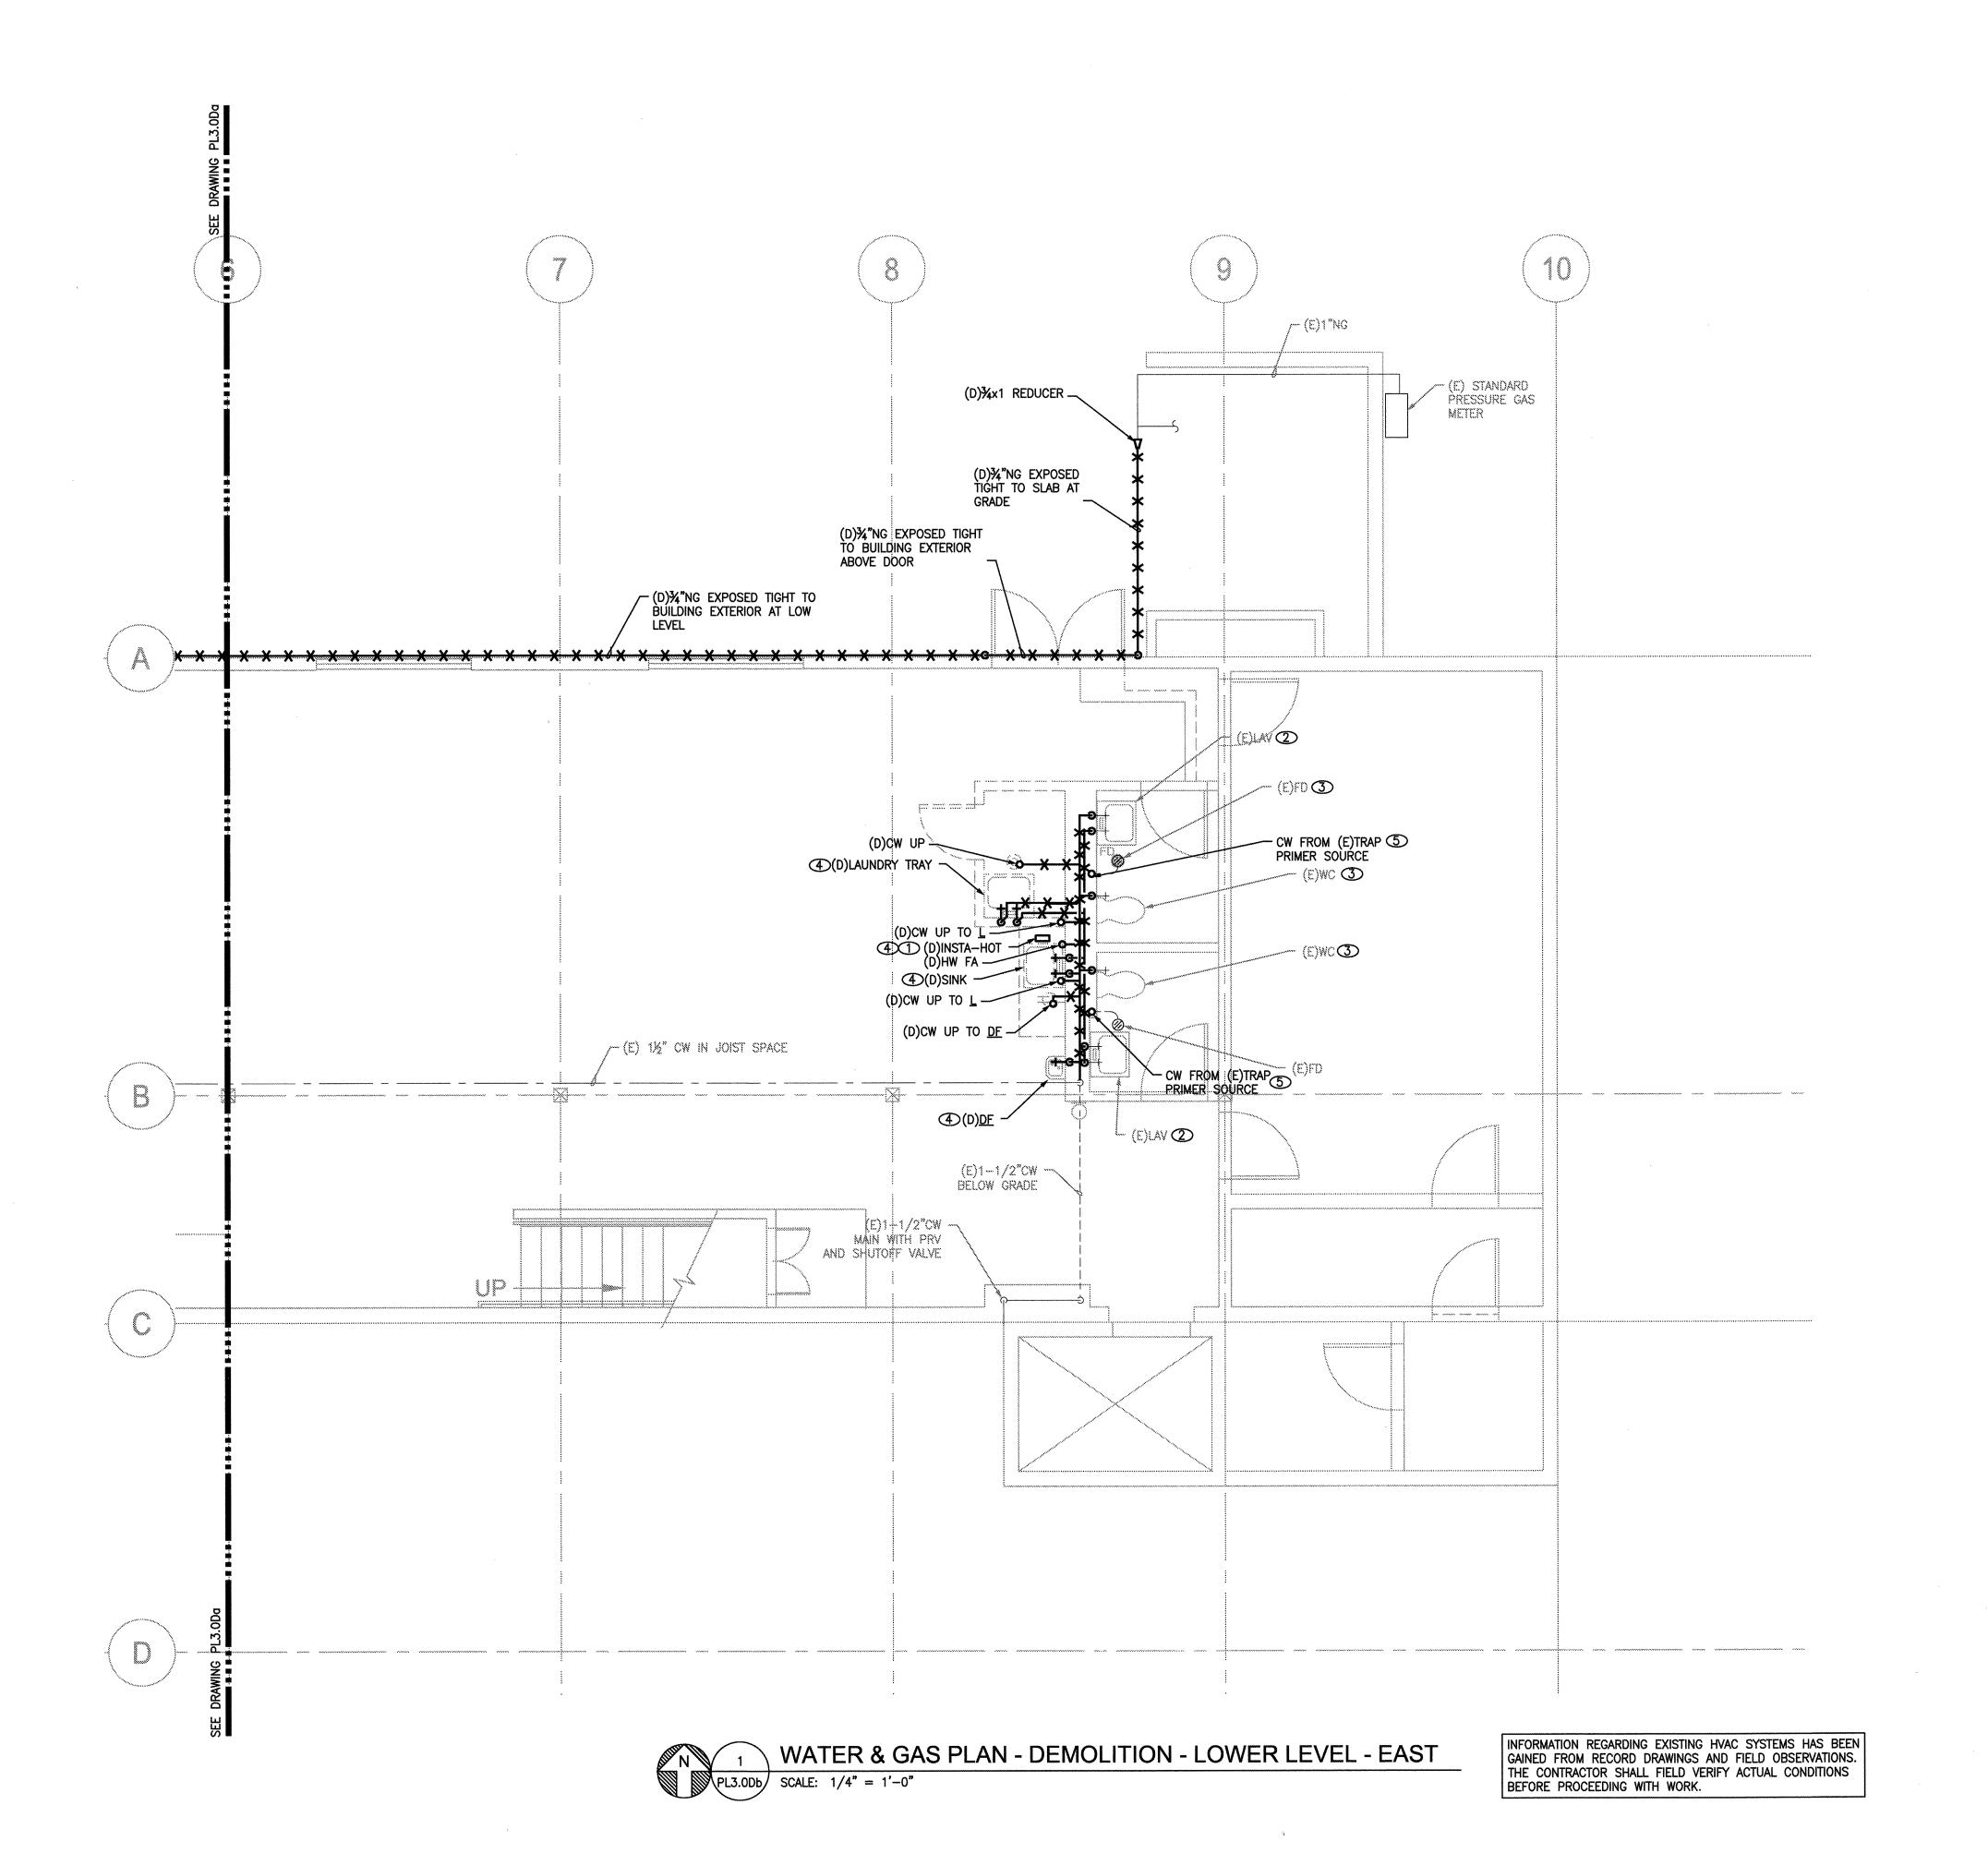

- A. SEE GENERAL PLUMBING NOTES ON DRAWING PLO.
- B. SEE PLUMBING FIXTURE SCHEDULE FOR BRANCH LINE AND CONNECTION SIZES.
- C. DOMESTIC WATER SYSTEM IS BASED ON THE FOLLOWING INFORMATION AVAILABLE AT THE TIME OF SYSTEM DESIGN:
 MINIMUM AVAILABLE WATER PRESSURE: 70 PSIG
- MAXIMUM AVAILABLE WATER PRESSURE: 104 PSIG

 D. PROVIDE STOPS AND SUPPLIES FOR HW AND CW CONNECTIONS
 TO PLUMBING FIXTURES AND EQUIPMENT.
- E. PROVIDE TRAP PRIMERS AT ALL FLOOR DRAINS, UNLESS
- OTHERWISE NOTED.
- F. PROVIDE FIRESTOPPING, SLEEVES, AND SEALANTS AT FLOOR, WALL, AND CEILING PENETRATIONS; COORDINATE LOCATIONS WITH

KEYED NOTES

- ① COORDINATE DEMO OF POWER CONNECTION WITH DIV. 16.
- ② REMOVE (E) CW/HW STOPS FOR INSTALLATION.
- REMOVE AND REINSTALL (E) FLUSH VALVE TO ACCOMODATE NEW FLOORING; COORDINATE WITH GC PRIOR TO COMMENCEMENT OF WORK.
- DEMO PLUMBING FIXTURE AND ASSOCIATED WATER BRANCHES. CAP PIPING TO BE CONCEALED BY FINISH WORK.
- 5 CONTRACTOR TO LOCATE TRAP PRIMER SOURCE PRIOR TO COMMENCEMENT OF WORK.



R S

720 NW Davis Suite 300 Portland, OR 97209

Portland, OR 97209
Tel. 503.221.1121
Fax. 503.221.2077

Munro & Associates consulting engineers

Tualatin, Oregon 97062 tel 503.612.6500 fax 503.612.6588

CONSULTANTS


SENIOR CENTER
ON AND ADDITION
SW O'MARA ST.
D, OREGON 97223

RENO WA

TF. 00 20 07


CHECK:

PROJECT: 207037

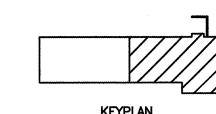

PL3.0Db



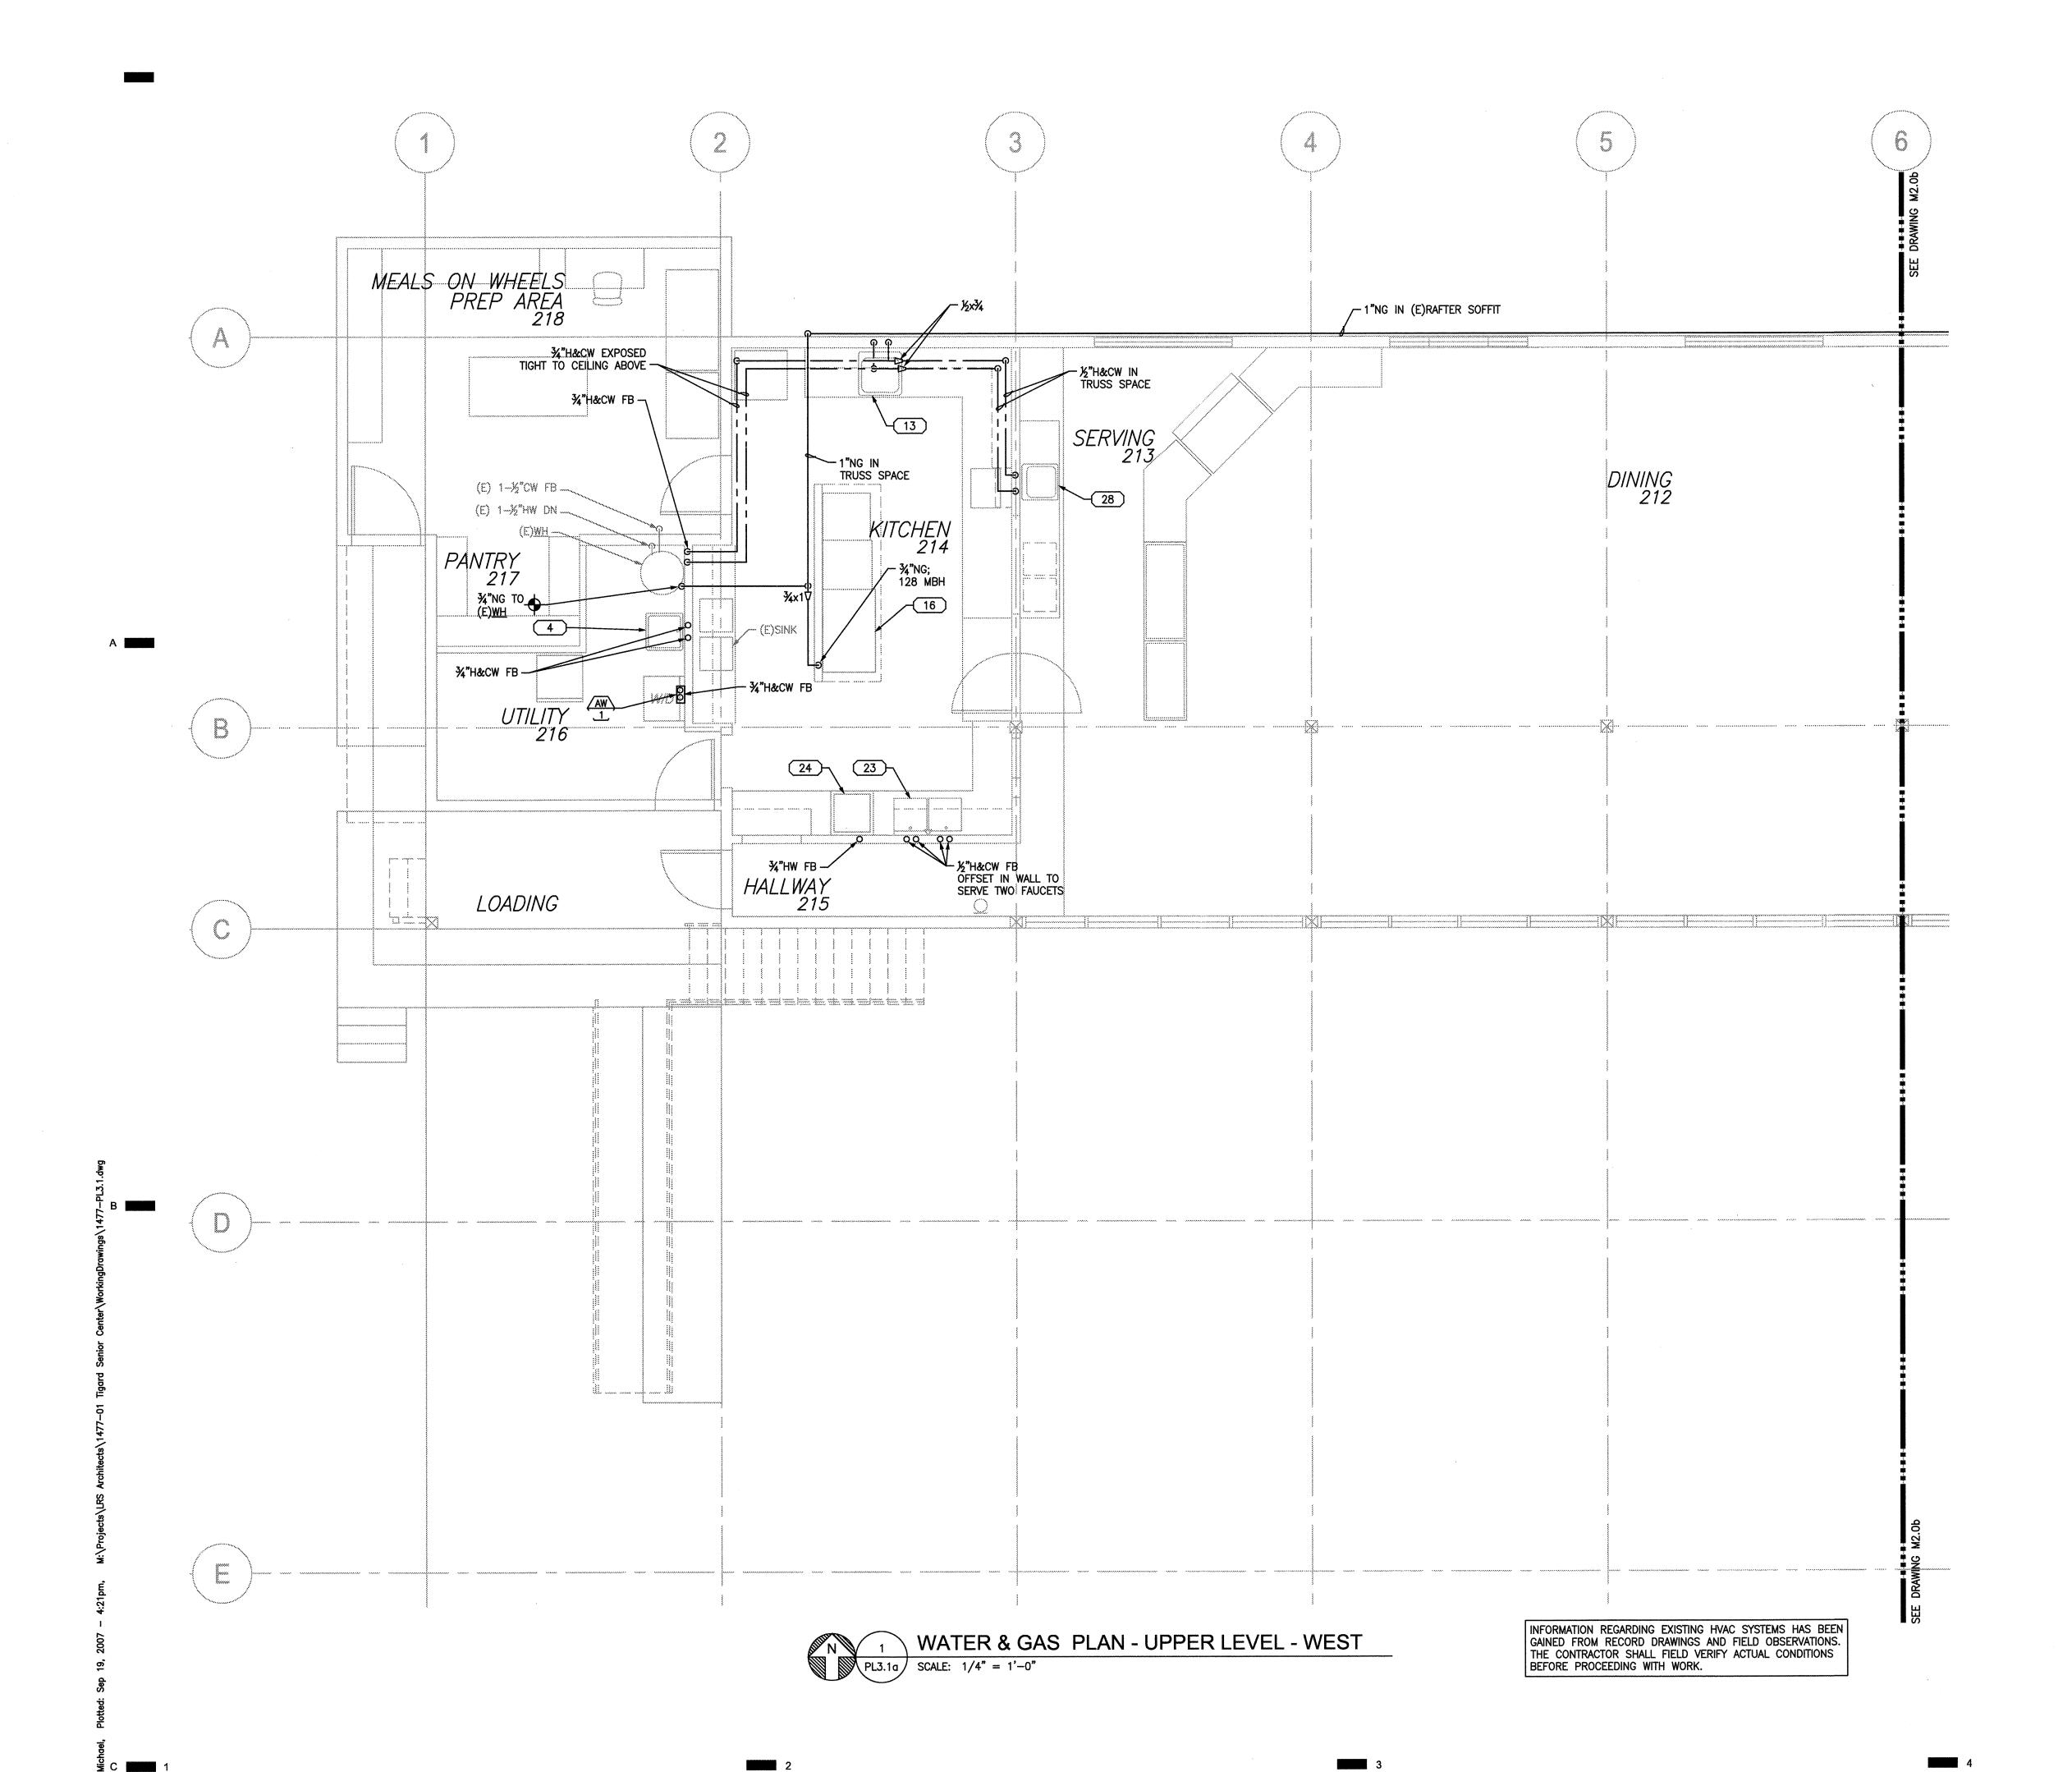



- A. SEE GENERAL PLUMBING NOTES ON DRAWING PLO.
- B. SEE PLUMBING FIXTURE SCHEDULE FOR BRANCH LINE AND CONNECTION SIZES.
- C. DOMESTIC WATER SYSTEM IS BASED ON THE FOLLOWING INFORMATION AVAILABLE AT THE TIME OF SYSTEM DESIGN:

 MINIMUM AVAILABLE WATER PRESSURE: 70 PSIG MAXIMUM AVAILABLE WATER PRESSURE: 104 PSIG
- D. PROVIDE STOPS AND SUPPLIES FOR HW AND CW CONNECTIONS
 TO PLUMBING FIXTURES AND EQUIPMENT.
- E. PROVIDE TRAP PRIMERS AT ALL FLOOR DRAINS, UNLESS
- OTHERWISE NOTED.
- F. PROVIDE FIRESTOPPING, SLEEVES, AND SEALANTS AT FLOOR, WALL, AND CEILING PENETRATIONS; COORDINATE LOCATIONS WITH GC.



RS

720 NW Davis Suite 300 Portland, OR 97209 Tel. 503.221.1121

Fax. 503.221.2077

Munro & Associates consulting engineers
18678 SW Boones Ferry Rd Tualatin, Oregon 97062

Tualatin, Oregon 97062 tel 503.612.6500 fax 503.612.6588

CONSULTANTS


NED SENIOR CENTER
VATION AND ADDITION
8815 SW O'MARA ST.
FIGARD, OREGON 97223
TER & GAS PLAN

PROJECT NAM

: 09.20.0

CHECK:


PROJECT: 207

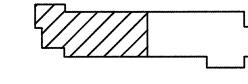

KEYPLA

PL3.1a



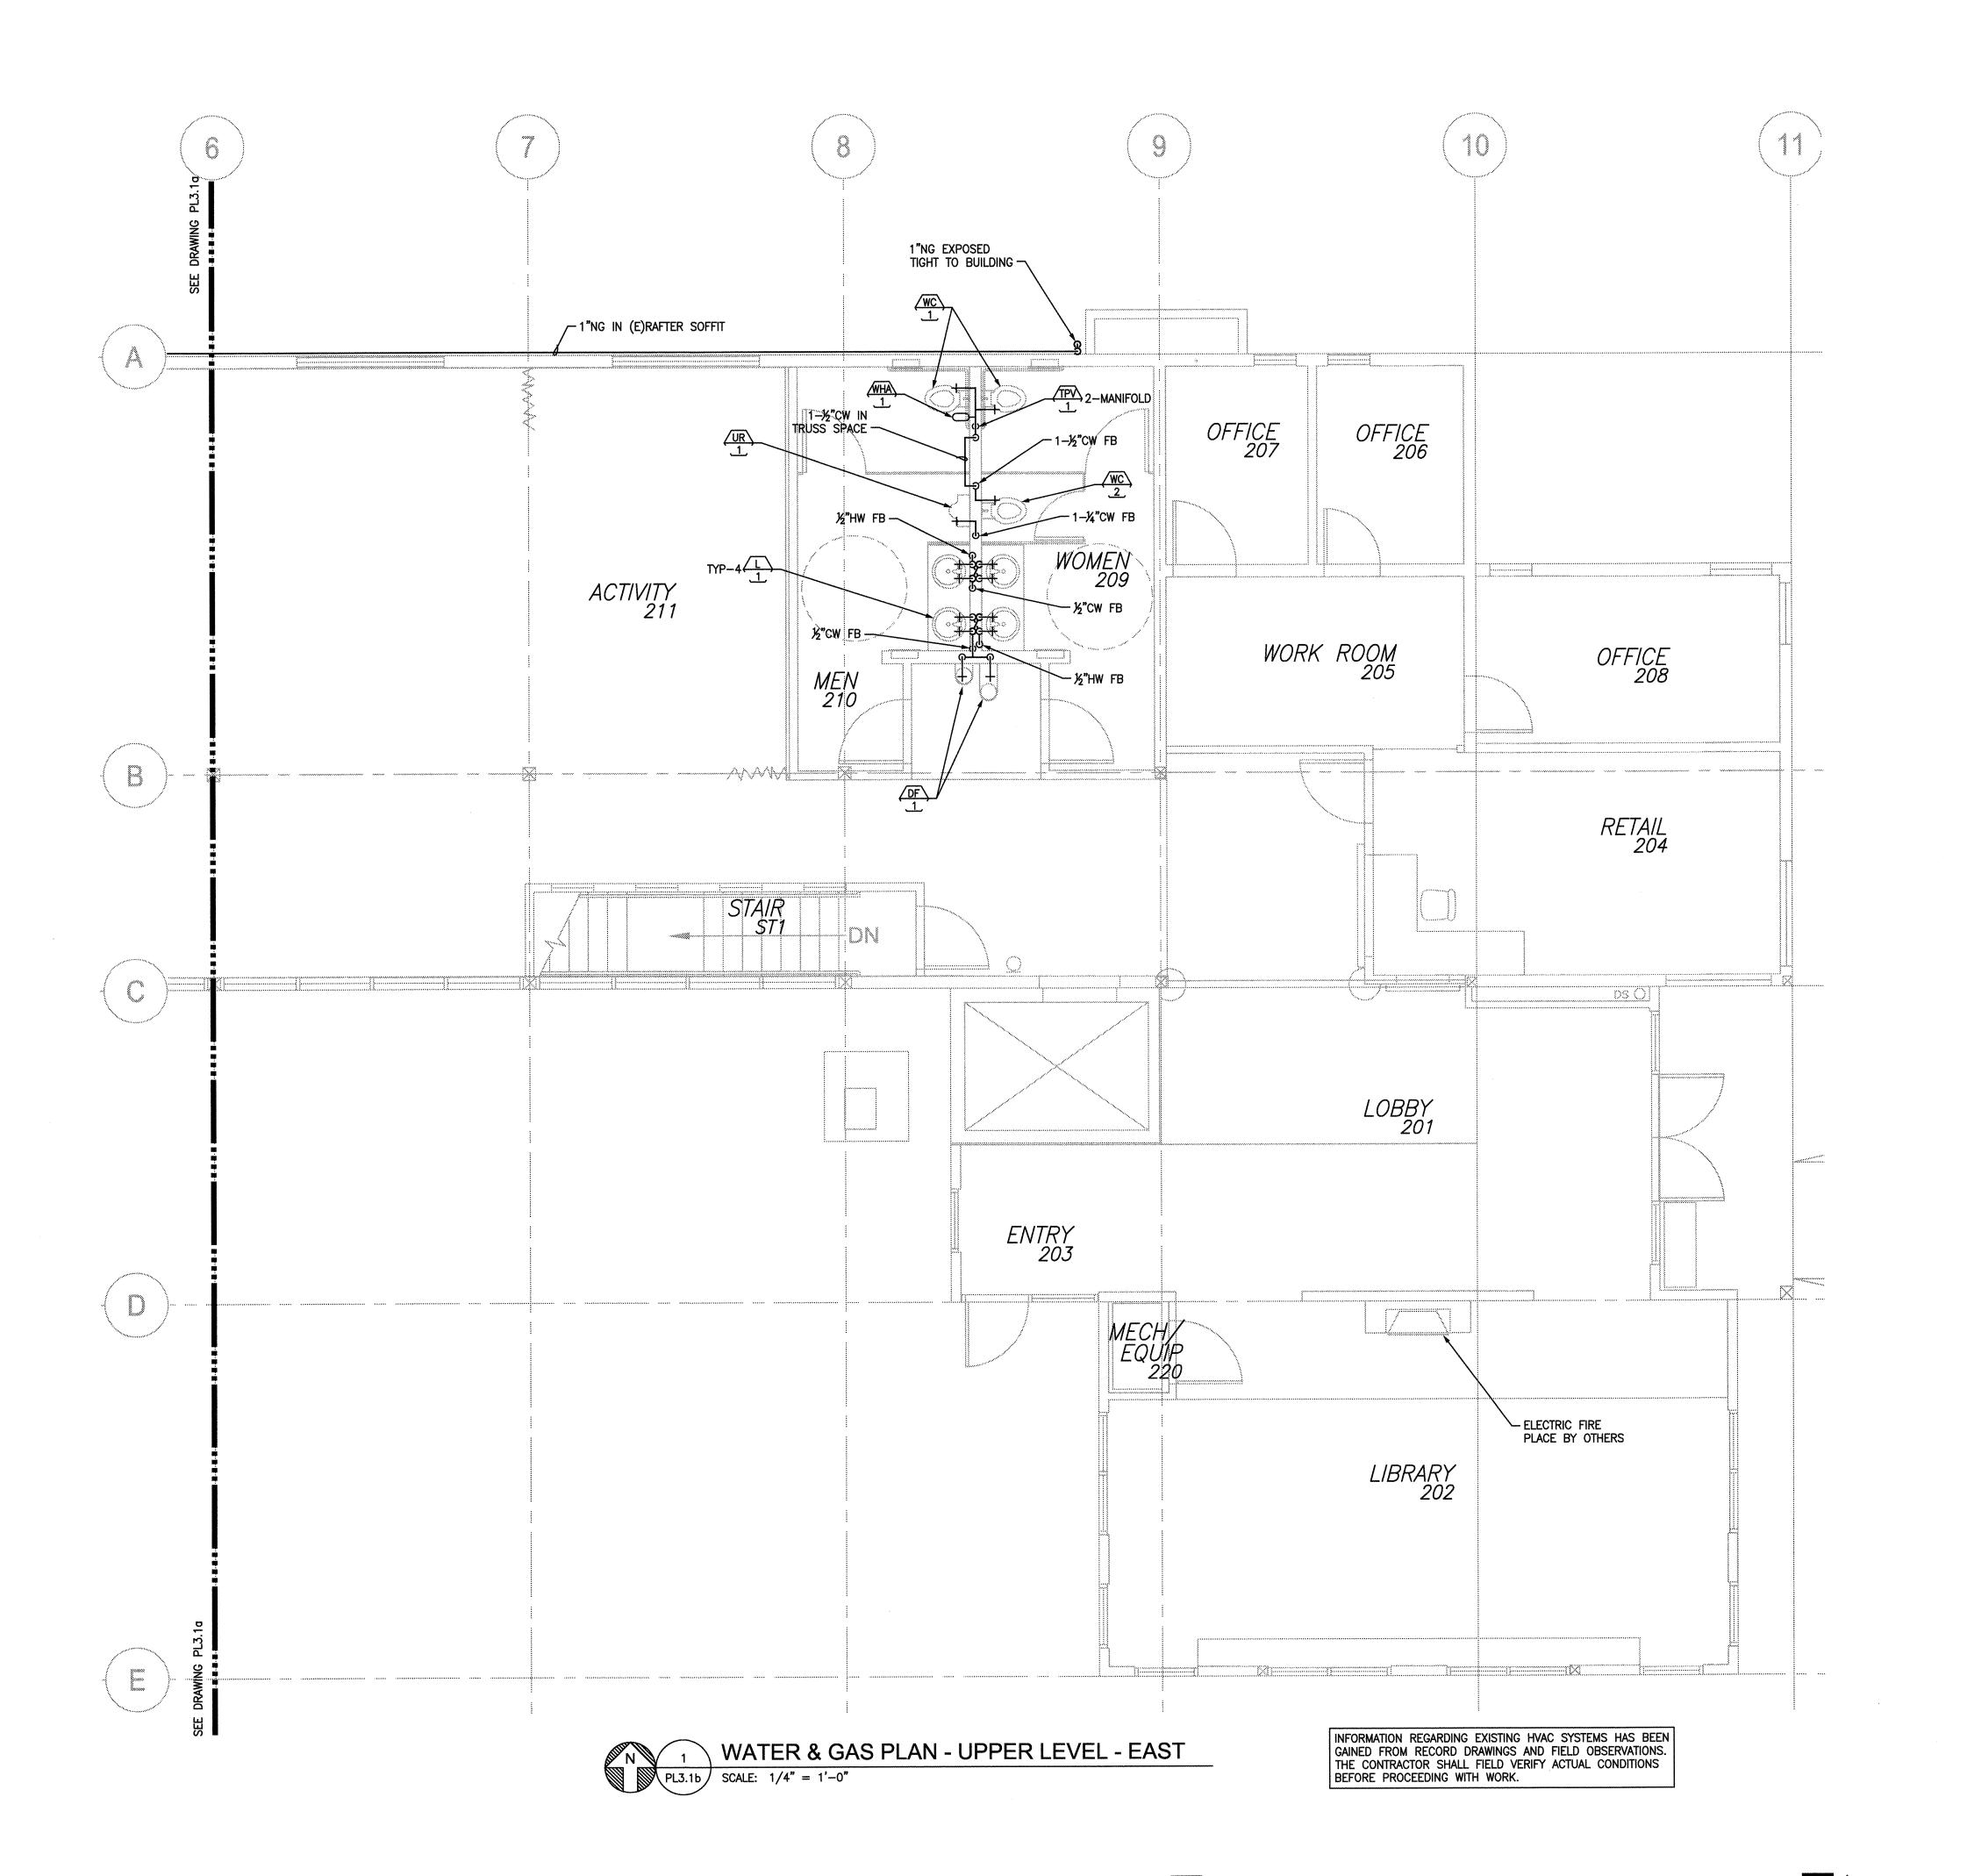



- A. SEE GENERAL PLUMBING NOTES ON DRAWING PLO. B. SEE PLUMBING FIXTURE SCHEDULE FOR BRANCH LINE AND CONNECTION SIZES.
- C. DOMESTIC WATER SYSTEM IS BASED ON THE FOLLOWING INFORMATION AVAILABLE AT THE TIME OF SYSTEM DESIGN: MINIMUM AVAILABLE WATER PRESSURE: 70 PSIG MAXIMUM AVAILABLE WATER PRESSURE: 104 PSIG
- D. PROVIDE STOPS AND SUPPLIES FOR HW AND CW CONNECTIONS TO PLUMBING FIXTURES AND EQUIPMENT.
- E. PROVIDE TRAP PRIMERS AT ALL FLOOR DRAINS, UNLESS OTHERWISE NOTED.
- F. PROVIDE FIRESTOPPING, SLEEVES, AND SEALANTS AT FLOOR, WALL, AND CEILING PENETRATIONS; COORDINATE LOCATIONS WITH GC.



LRS a

720 NW Davis Suite 300 Portland, OR 97209 Tel. 503.221.1121

Fax. 503.221.2077

mxa


Munro & Associates consulting engineers

18678 SW Boones Ferry Rd Tualatin, Oregon 97062 tel 503.612.6500 fax 503.612.6588


CONSULTANTS


CENTER

PROJECT NAME	

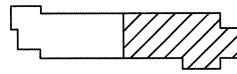

PL3.1b

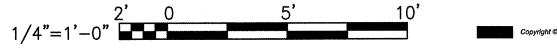

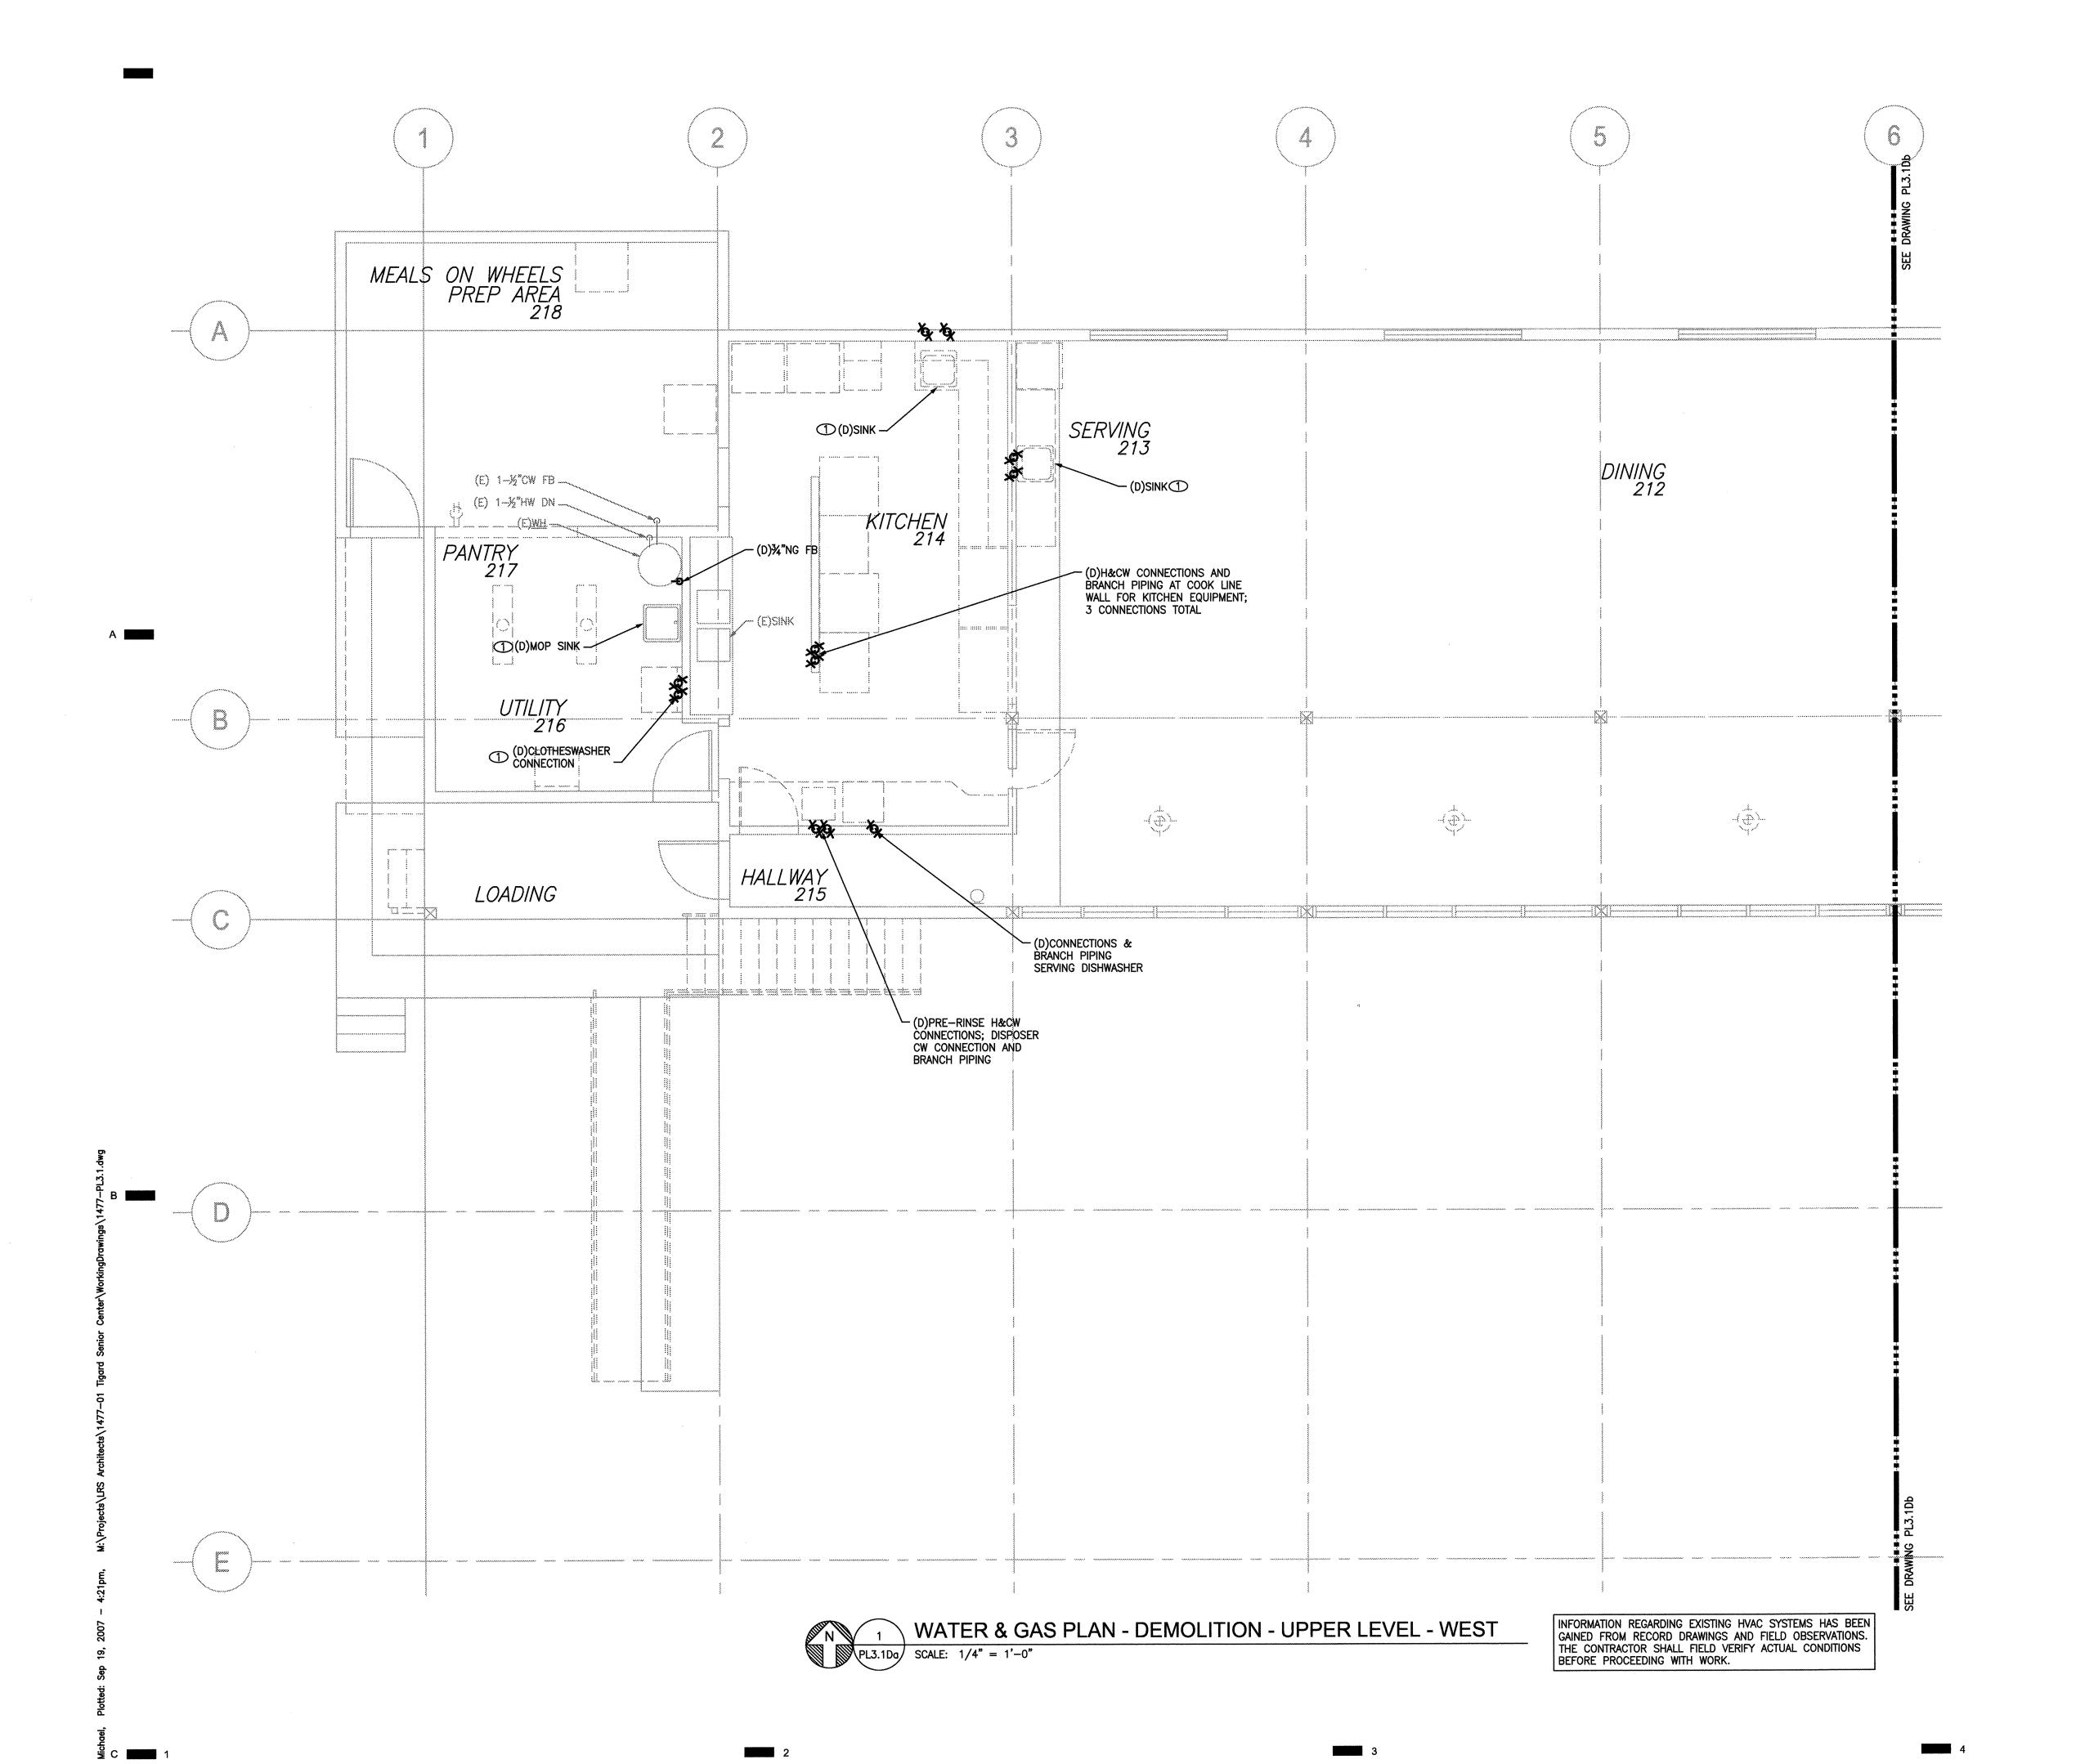



A. SEE GENERAL PLUMBING NOTES ON DRAWING PLO.B. SEE PLUMBING FIXTURE SCHEDULE FOR BRANCH LINE AND CONNECTION SIZES.

C. DOMESTIC WATER SYSTEM IS BASED ON THE FOLLOWING INFORMATION AVAILABLE AT THE TIME OF SYSTEM DESIGN:
MINIMUM AVAILABLE WATER PRESSURE: 70 PSIG

MAXIMUM AVAILABLE WATER PRESSURE: 104 PSIG

D. PROVIDE STOPS AND SUPPLIES FOR HW AND CW CONNECTIONS
TO PLUMBING FIXTURES AND EQUIPMENT.

E. PROVIDE TRAP PRIMERS AT ALL FLOOR DRAINS, UNLESS

OTHERWISE NOTED.

F. PROVIDE FIRESTOPPING, SLEEVES, AND SEALANTS AT FLOOR, WALL, AND CEILING PENETRATIONS; COORDINATE LOCATIONS WITH

KEYED NOTES

① DEMO PLUMBING FIXTURE AND ASSOCIATED WATER BRANCHES.



R S

720 NW Davis Suite 300 Portland, OR 97209 Tel. 503.221.1121

Fax. 503.221.2077

mya

Munro & Associates consulting engineers

18678 SW Boones Ferry Rd Tualatin, Oregon 97062 tel 503.612.6500 fax 503.612.6588

CONSULTANTS

RD SENIOR CENTEI YATION AND ADDITION 8815 SW O'MARA ST. IGARD, OREGON 97223 TER & GAS PLAN


PROJECT NAME

. 09.20.07

CHECK: LD


PROJECT: 207037


| DRAWN BY:

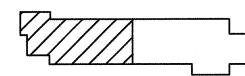

KEYPLA

PL3.1Da

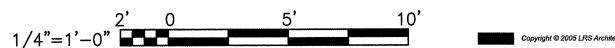

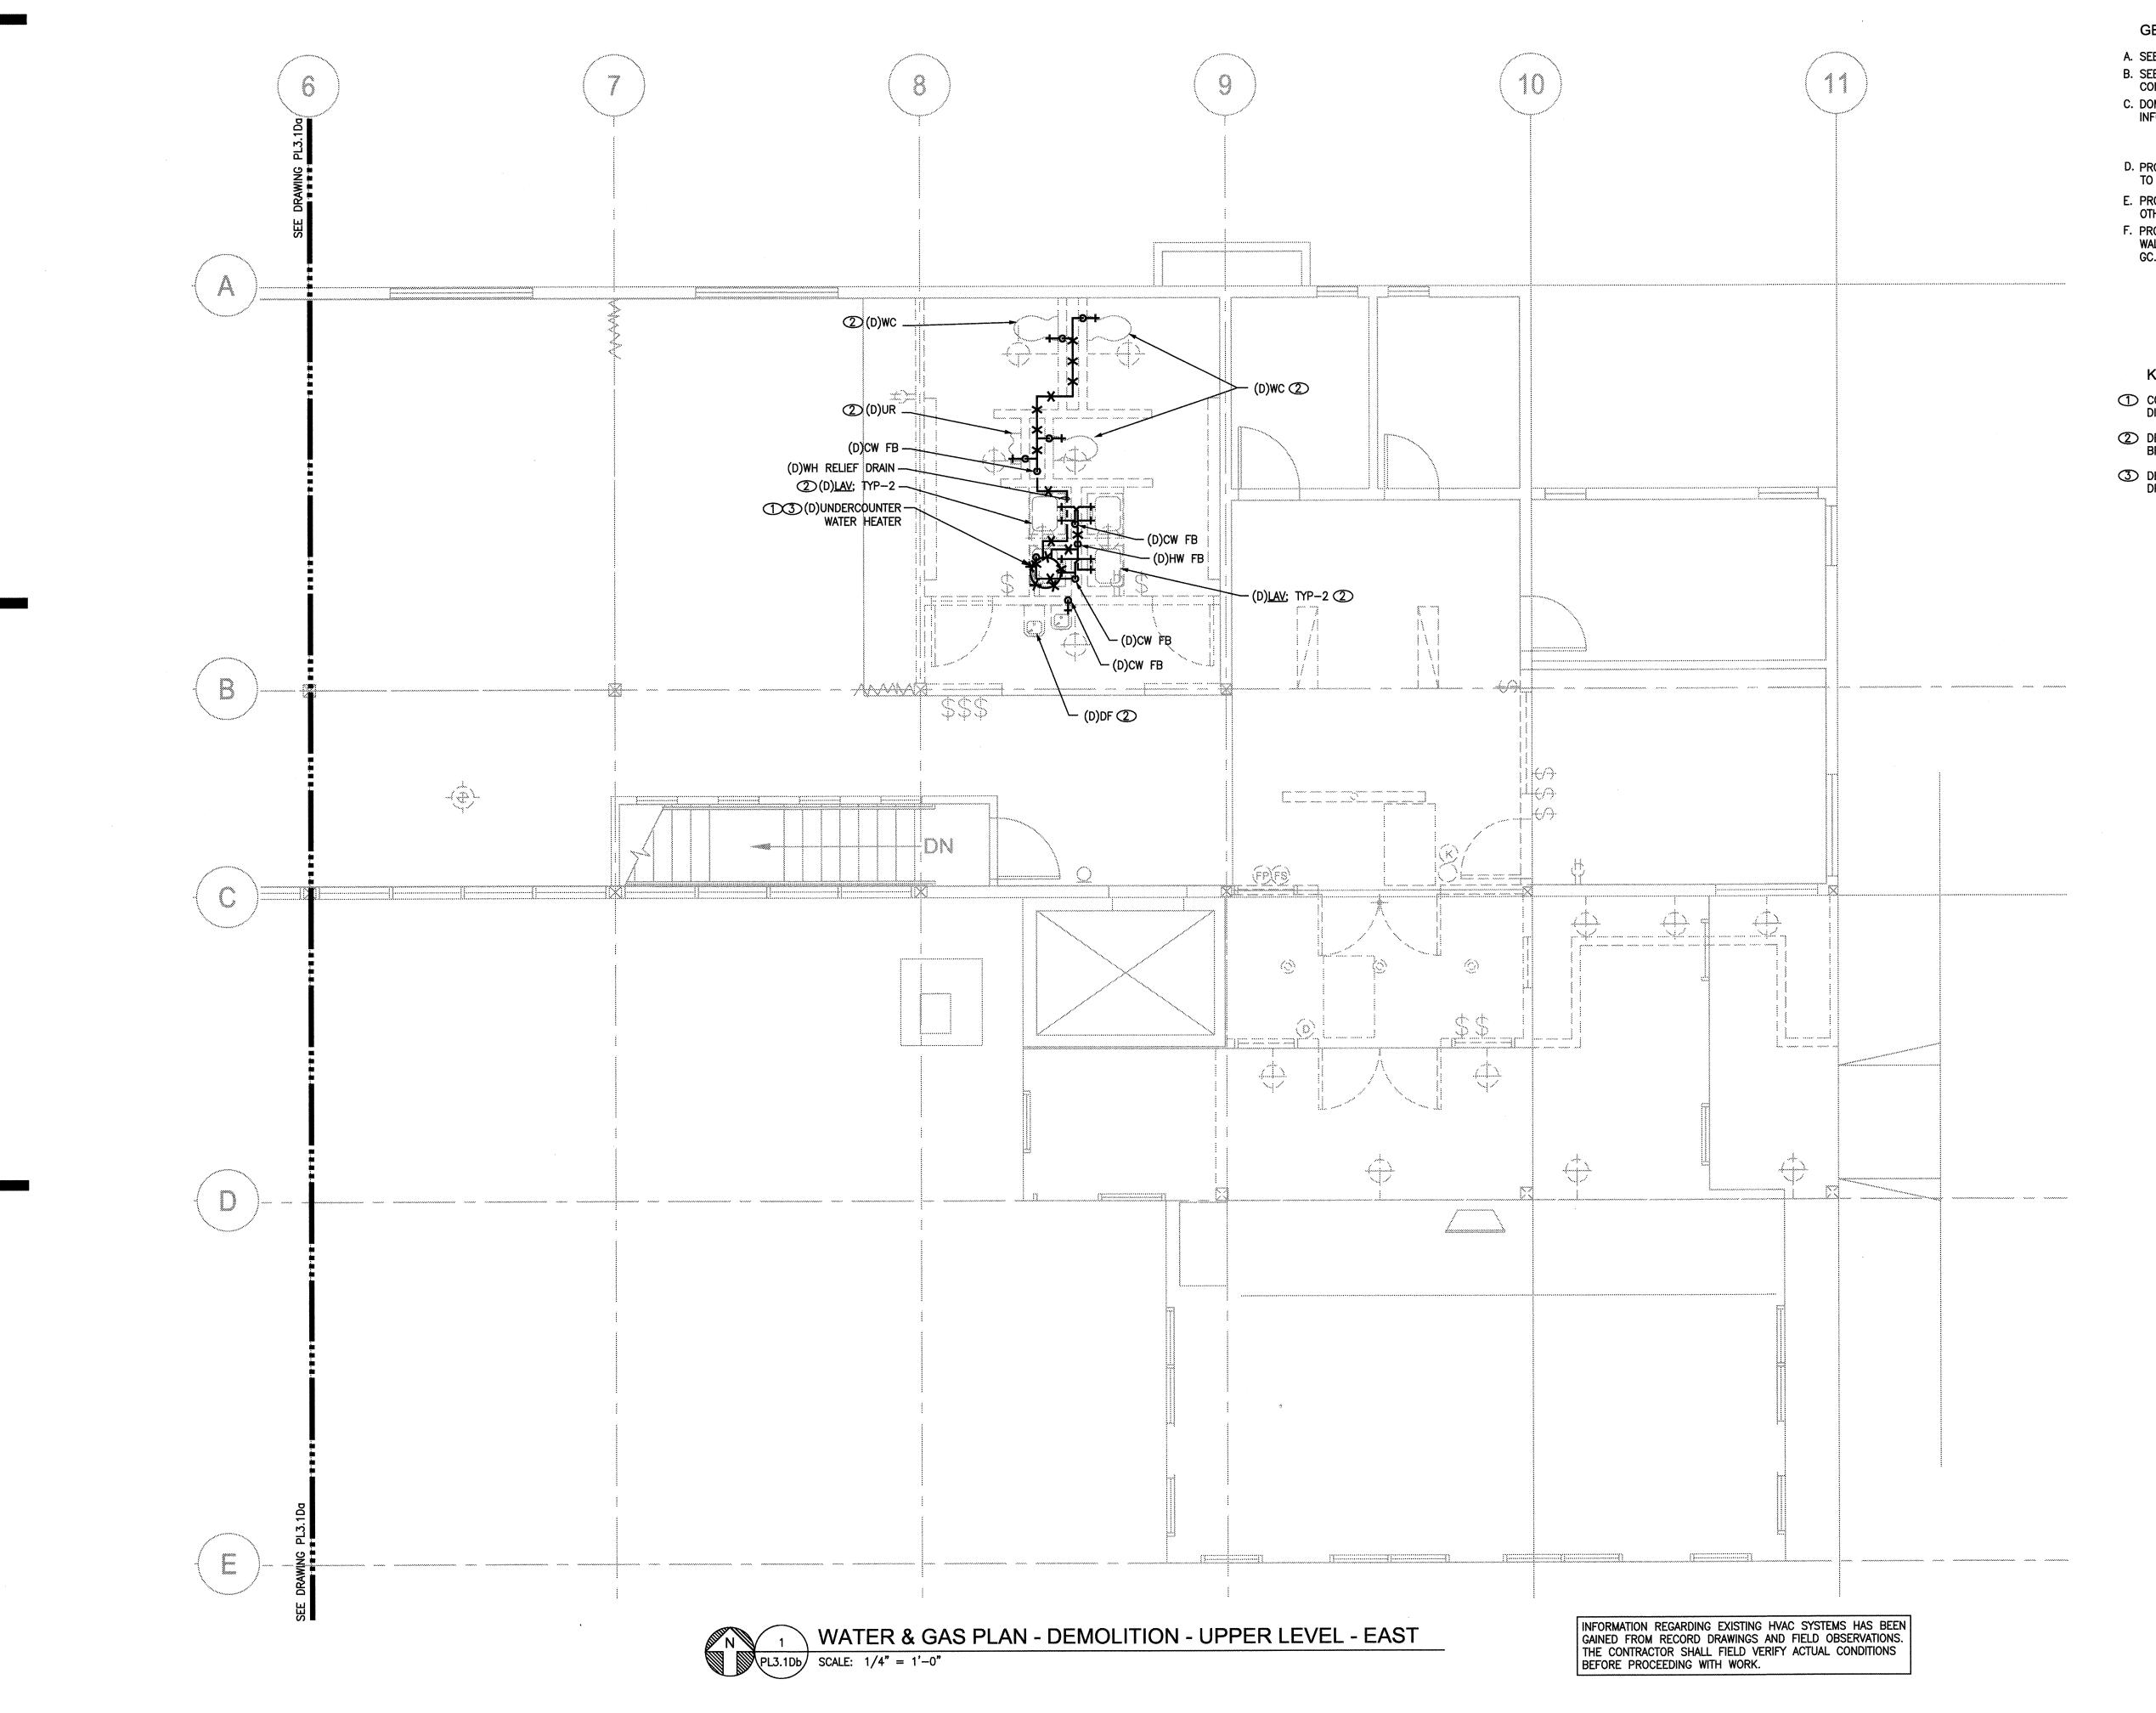



- A. SEE GENERAL PLUMBING NOTES ON DRAWING PLO.
- B. SEE PLUMBING FIXTURE SCHEDULE FOR BRANCH LINE AND CONNECTION SIZES.
- C. DOMESTIC WATER SYSTEM IS BASED ON THE FOLLOWING INFORMATION AVAILABLE AT THE TIME OF SYSTEM DESIGN:
 MINIMUM AVAILABLE WATER PRESSURE: 70 PSIG
- MAXIMUM AVAILABLE WATER PRESSURE: 104 PSIG

 D. PROVIDE STOPS AND SUPPLIES FOR HW AND CW CONNECTIONS
 TO PLUMBING FIXTURES AND EQUIPMENT.
- E. PROVIDE TRAP PRIMERS AT ALL FLOOR DRAINS, UNLESS OTHERWISE NOTED.
- F. PROVIDE FIRESTOPPING, SLEEVES, AND SEALANTS AT FLOOR, WALL, AND CEILING PENETRATIONS; COORDINATE LOCATIONS WITH

KEYED NOTES

- 1 COORDINATE DEMOLITION OF POWER BRANCH FEEDER WITH
- ② DEMO PLUMBING FIXTURE AND ASSOCIATED WATER PIPING BRANCHES.
- 3 DEMO PLUMBING EQUIPMENT AND ASSOCIATED WATER AND DRAIN BRANCHES.



P S

720 NW Davis
Suite 300
Portland, OR 97209
Tel. 503.221.1121
Fax. 503.221.2077

Munro & Associates

Associates
consulting
engineers

18678 SW Boones Ferry Rd
Tualatin, Oregon 97062
tel 503.612.6500
fax 503.612.6588

CONSULTANTS

SENIOR CENTER TION AND ADDITION 5 SW O'MARA ST. RD, OREGON 97223 R & GAS PLAN

RENC

PROJECT NAME


.....

E: 09.20.07


DDO IECT. 207

KFYPI

PL3.1Db

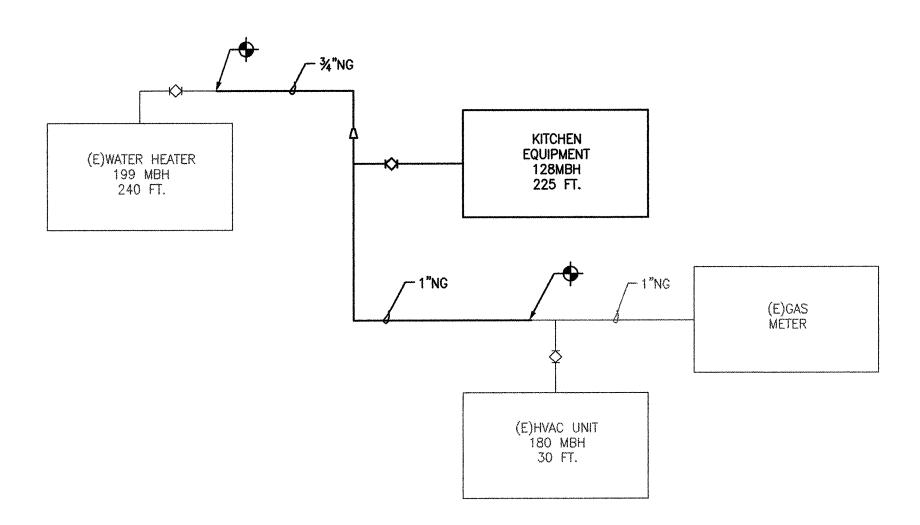


NATURAL GAS DIAGRAM PL4.0 SCALE: NONE

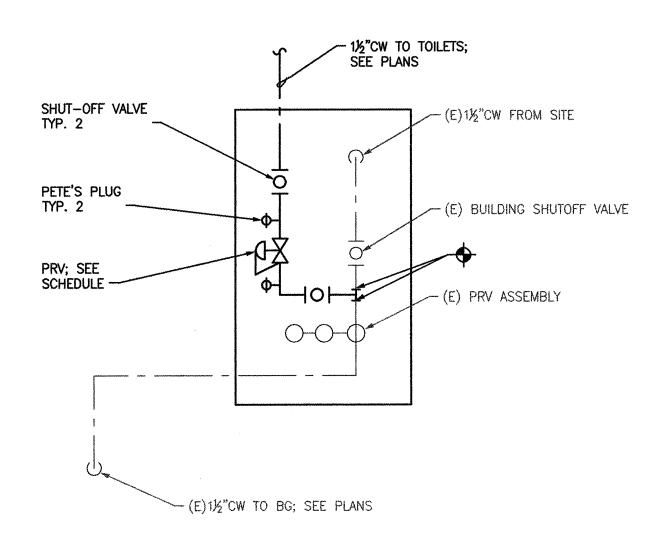


PRESSURE REDUCING VALVE

SCALE: NONE

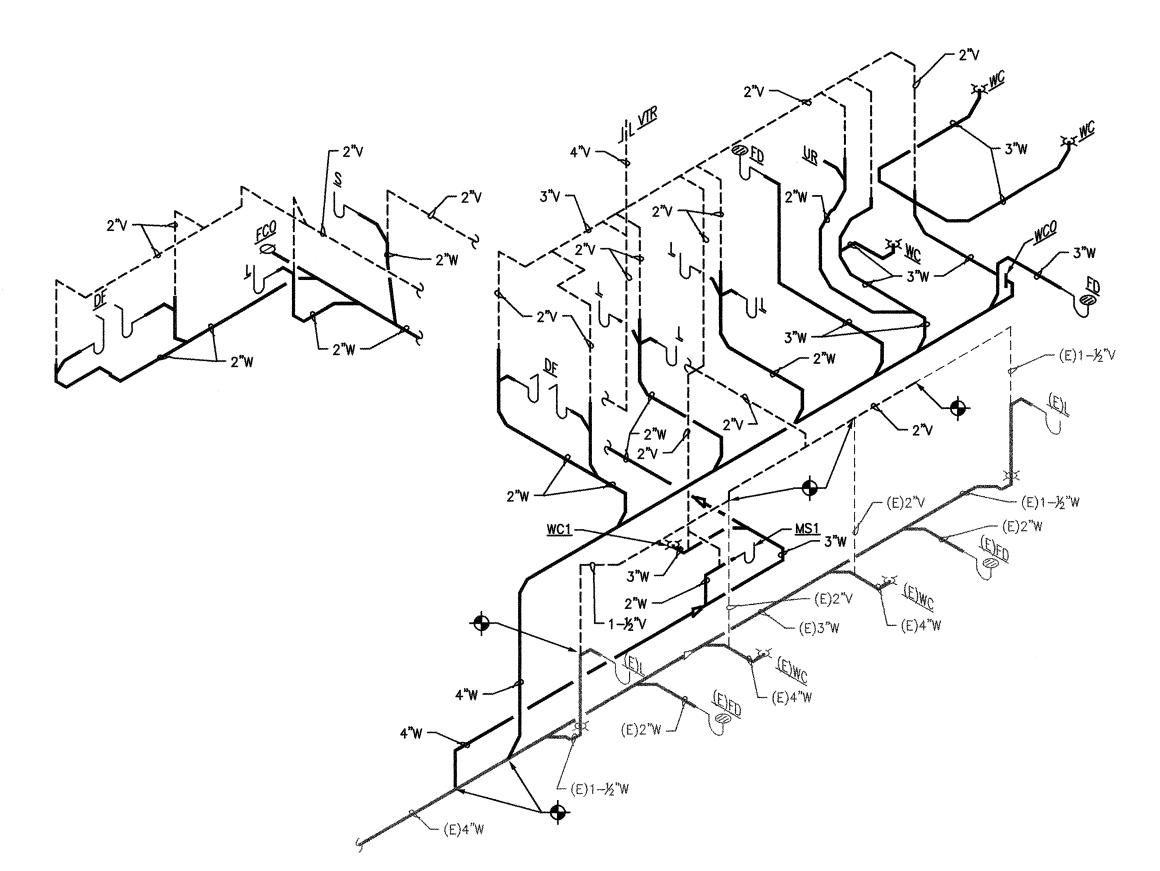

1 WASTE & VENT ISOMETRIC - EAST
PL4.0 SCALE: NONE

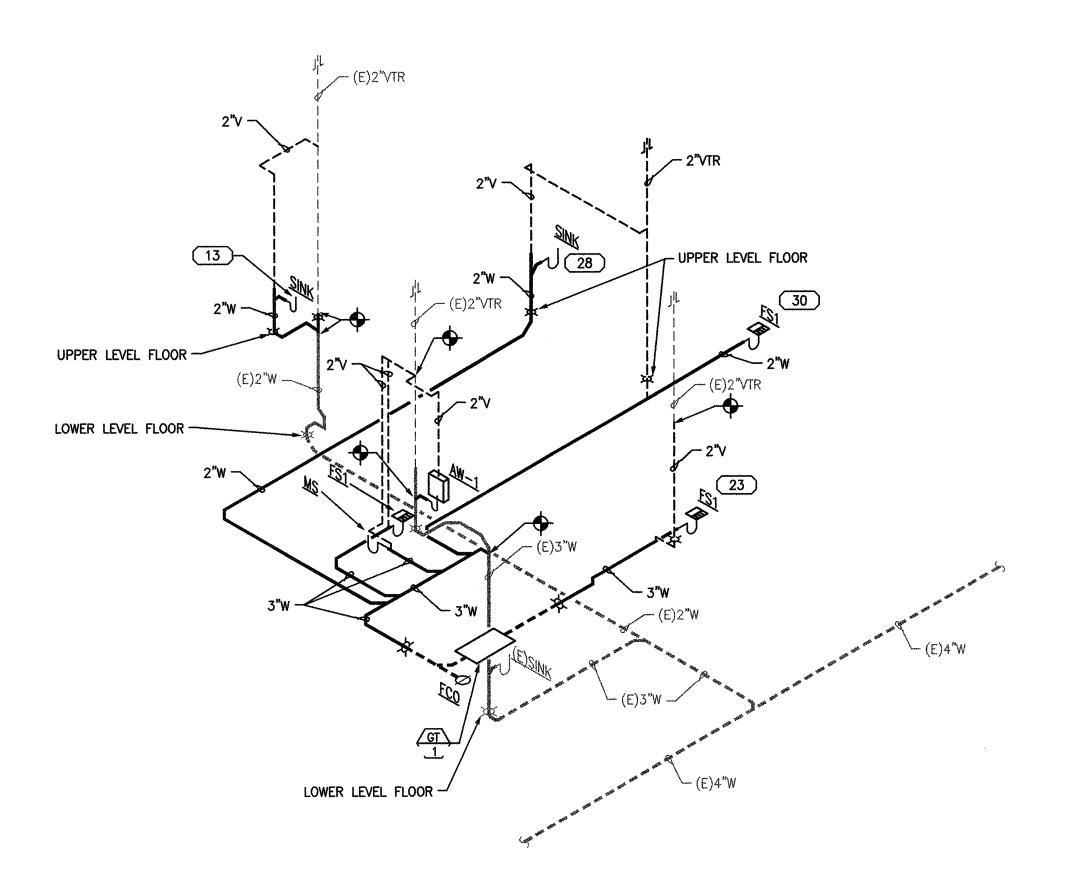

WASTE & VENT ISOMETRIC - WEST
PL4.0 SCALE: NONE

STAGINE SOLD STAGING OREGON

SOLD T. HOOLE

Expires: 4500 69

720 NW Davis Suite 300 Portland, OR 97209 Tel. 503.221.1121 Fax. 503.221.2077

> Munro & Associates consulting engineers

18678 SW Boones Ferry Rd Tualatin, Oregon 97062 tel 503.612.6500 fax 503.612.6588

CONSULTANTS

ATION AND ADDITION AND ADDITION S815 SW O'MARA ST. SARD, OREGON 97223

PROJECT NAME

ATE: 09.20.07

DRAWN BY:

PROJECT: 207037

PI40

Copyright © 2005 LRS Architects, Inc.